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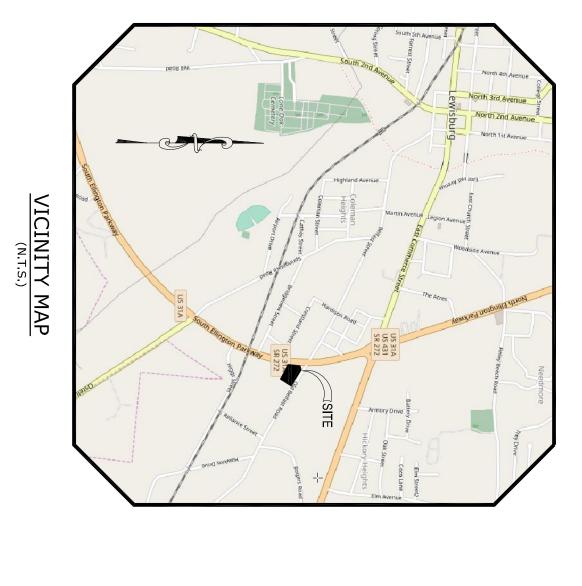
Consultant:
Ferlisi Civil Design
P.O. Box 5
Cornersville, TN 37047
Contact: David Ferlisi
ferlisicivildesign@att.net
ph: 615.957.2338

Developer:
Cameron J. Coble, II
1028 Nashville Hwy.
Lewisburg, TN 37091
Contact: CJ Coble
ph: 931.637.0898

Surveyor:
Reese Land Surveying
112 East Commerce St.
Lewisburg, TN 37091
Contact: Todd Reese, PLS
rls2648@gmail.com
ph: 931.625.2480

Permit-Seal:

PARED ENGLISHED ENGLISHED



Multifamily Residential 915 Old Belfast Road 3rd Civil District Lewisburg, Marshall County, TN

Revisions:

Cameron J. Coble, II 1028 Nashville Highway Lewisburg, TN 37097

Client/Project:

915 Old Befast Road

3rd Civil District wisburg, Marshall County, Tennessee Date: August 24, 2022

TOTAL DISTURBED AREA = 37,676 SF $(0.86\pm$ AC)

SHEET INDEX:

Ttle


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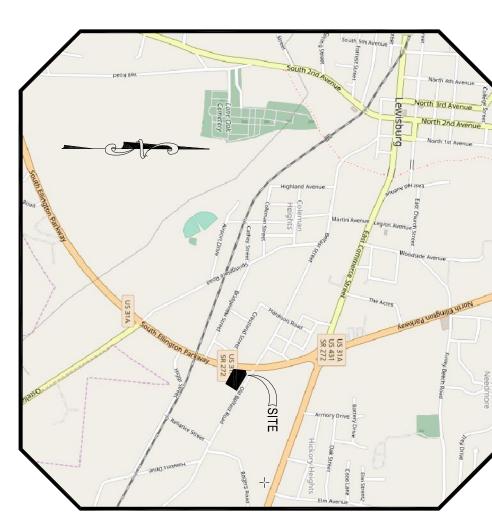
TITLE SHEET

C3.3 N	C3.2 N	C3.1 N	C2.3 F	C2.2	C2.1 S	C1.1 S	C0.1 E	A0.1 E	SP0.1 S	T1.0	
C3.3 MISCELLANEOUS DETAILS	MISCELLANEOUS DETAILS	MISCELLANEOUS DETAILS	FINAL STORM WATER POLUTION PREVENTION PLAN (SWPPP)	INITIAL STORM WATER POLUTION PREVENTION PLAN (SWPPP)	SITE GRADING & DRAINAGE PLAN	SITE LAYOUT & UTILITY PLAN	EXISTING CONDITIONS & DEMOLITION PLAN	BUILDING ELEVATIONS	SP0.1 SITE PLAN	T1.0 TITLE SHEET	

Designed By:
Drawn By:
Checked By: Project No.: DPF DPF BH 8/24/22 Date:






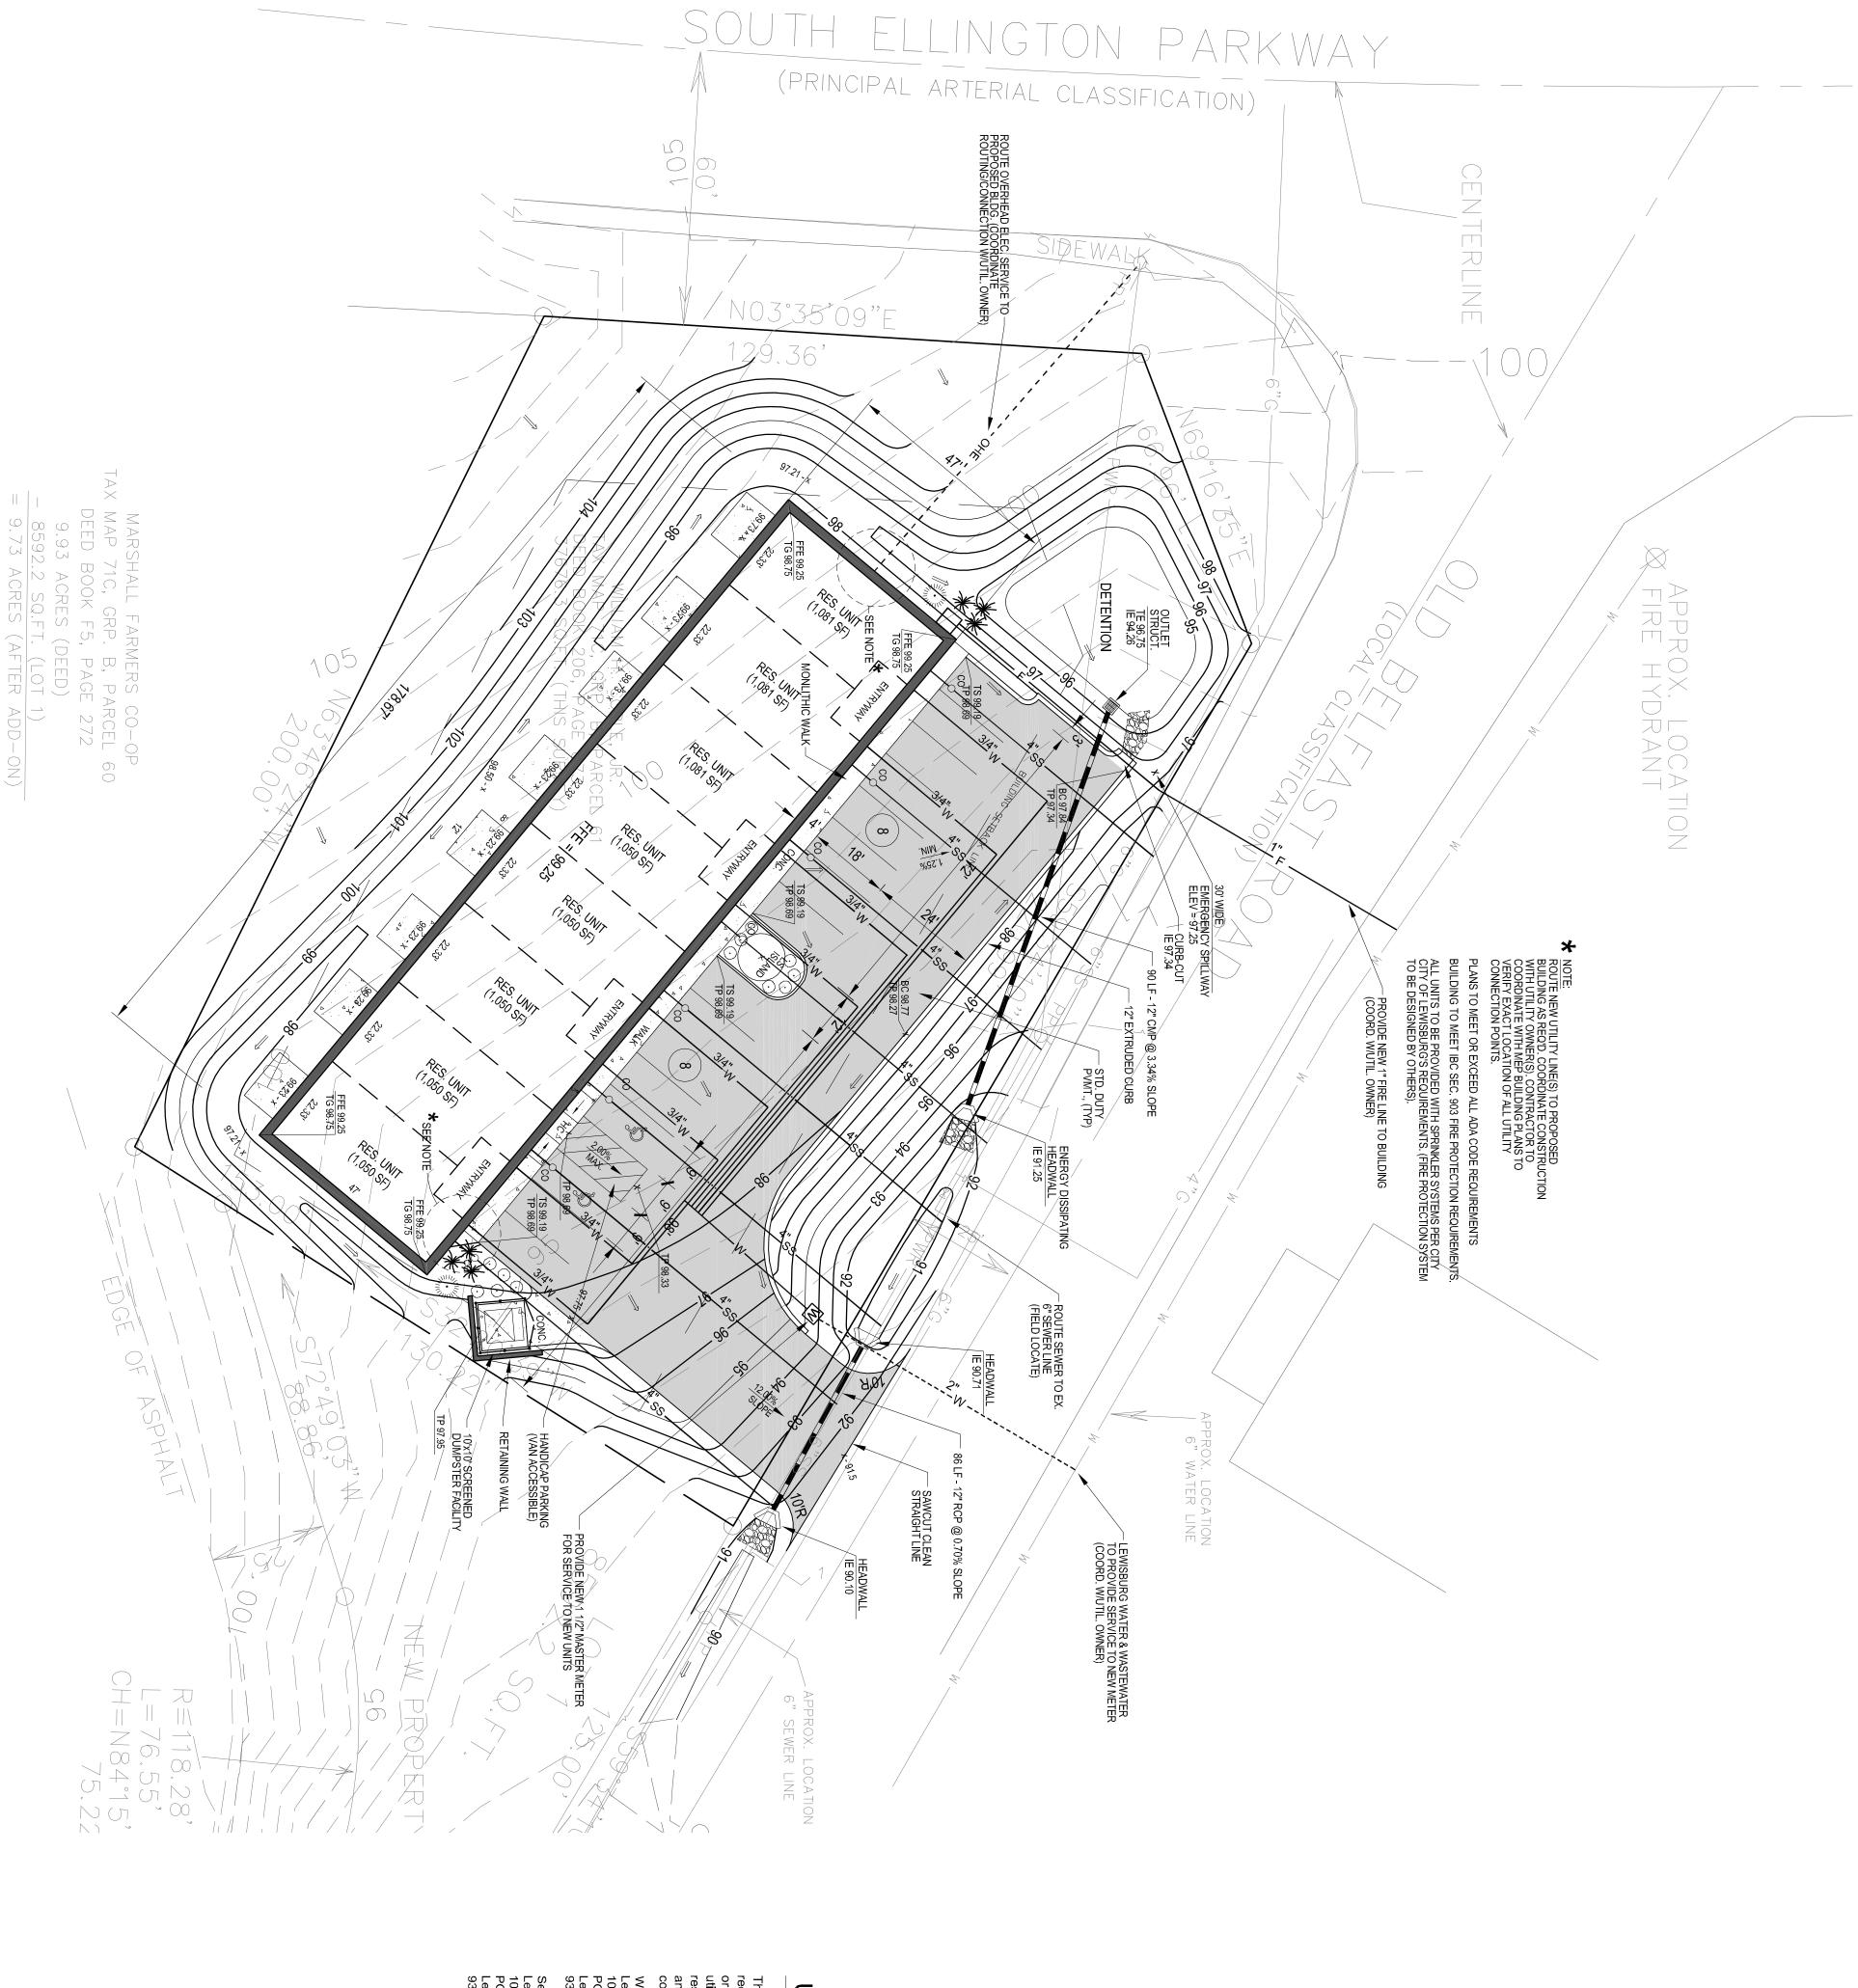



Permit-Seal:

Design Sei

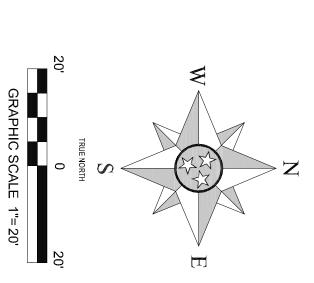

Client/Project:

Cameron J. Coble, II 1028 Nashville Highway Lewisburg, TN 37097

Nashville Civil LLC	Contact: David Ferlisi
	Cornersville, TN 37047
	P.O. Box 5
	Ferlisi Civil Design
In cooperation with:	Civil Consultant:
ph: 931.625.2480	
rls2648@gmail.com	ph: 931.637.0898
Contact: Todd Reese, PLS	Contact: CJ Coble
Lewisburg, TN 37091	Lewisburg, TN 37091
112 East Commerce St.	1028 Nashville Hwy.
Reese Land Surveying	Cameron J. Coble, II
Surveyor:	Developer:

Multifamily Residential 915 Old Belfast Road 3rd Civil District Lewisburg, Marshall County, TN

Revisions:

Date

UTILITY NOTES AND OWNERS

Lewisburg Water & Wastewater 100 Water Street PO Box 2787 Lewisburg, TN 37091 931-359-6831 Lewisburg Water & Was 100 Water Street PO Box 2787 Lewisburg, TN 37091 931-359-6831 The utility information shown hereon was taken from actual field evidence, utility agency records, or any other available evidence. Other utilites may exist and may not be shown, or may vary from where shown. No guarantee is expressed or implied in reguard to the utility locations shown hereon. The Owner(s) and Contractor(s) should assume responsibility to verify utility existence, size, location, depth, and availability of service, and be soley responsible for contacting the utility location service prior to commencing construction. Gas Lewisburg Gas Company 505 N. Ellington Pkwy Lewisburg, TN 37091 931-359-4016 Electric
Lewisburg Electric System
599 W. Ellington Pkwy
Lewisburg, TN 37091
931-359-2544 Cable Charter Cable 1-855-872-0428 Telephone AT&T 1-800-626-9149

SITE DATA TABLE:		PROPOSED
CURRENT OWNER (1): MAILING ADDRESS: MAP AND PARCEL:	Cameron J. Coble, II 1028 Nashville Highway, Lewisburg, TN 37091 MAP 71C, GROUP 'B', PARCEL 61.00 R.O.M.C. D.B.206, PG.873 R.O.M.C.	
CITY: COUNTY: STATE:	LEWISBURG MARSHALL COUNTY TENNESSEE 3RD CIVIL DISTRICT	
FEMA COMMUNITY PANEL:	47117C0040 D (Property IS NOT in special flood hazard area) Dated: 09/28/2007	
PROPERTY ZONING: TOTAL SITE ACREAGE:	Currently zoning (R3) Residential 0.86 ± Acres	R3 37,676 SF
FRONT YARD: SIDE YARD: REAR YARD:	30 ft. 10 ft. 20 ft.	
BUILDING AREA BUILDING HEIGHT	Max. Bldg. Coverage (30%) Max. Height. 35 ft.	22% 20.67 FT
SITE ADDRESS:	915 Old Belfast Road Lewisburg. TN	

Project No. :		
-		

Public Works Lewisburg Public Works 927 5th Ave N Lewisburg, TN 37091 931-359-3563

	U	
•	_	

10,045 SF + 8,400 SF = 18,445 SF 19,231 SF NA

MIN. LOT AREA

POSED STRUCTURE

Max. Bldg. Coverage (30%)
Max. Height. 35 ft.

915 Old Belfast Road
Lewisburg. TN
(Marshall County)

MULTIFAMILY DWELLING UNIT (TOTAL)
(8) DWELLING UNITS
7500 SF / + 3500 sf per additional family (8 units)


MPERVIOUS SURFACE AREA POST DEVELOPMENT)


NEW PAVEMENT NEW BUILDINGS: NEW IMP. SRF. AREA:

TOTAL PERV. SRF. AREA: (51%)
NPDES / SWPPP PERMIT IS <u>NOT</u> REQUIRED (<1.0 AC)

PARKING REQUIREMENTS PER CATAGORY:

Designed By:
Drawn By:
Checked By:
Date: ∏ttle Scale: SITE PLAN DPF DPF DPF 8/24/22 AS NOTED

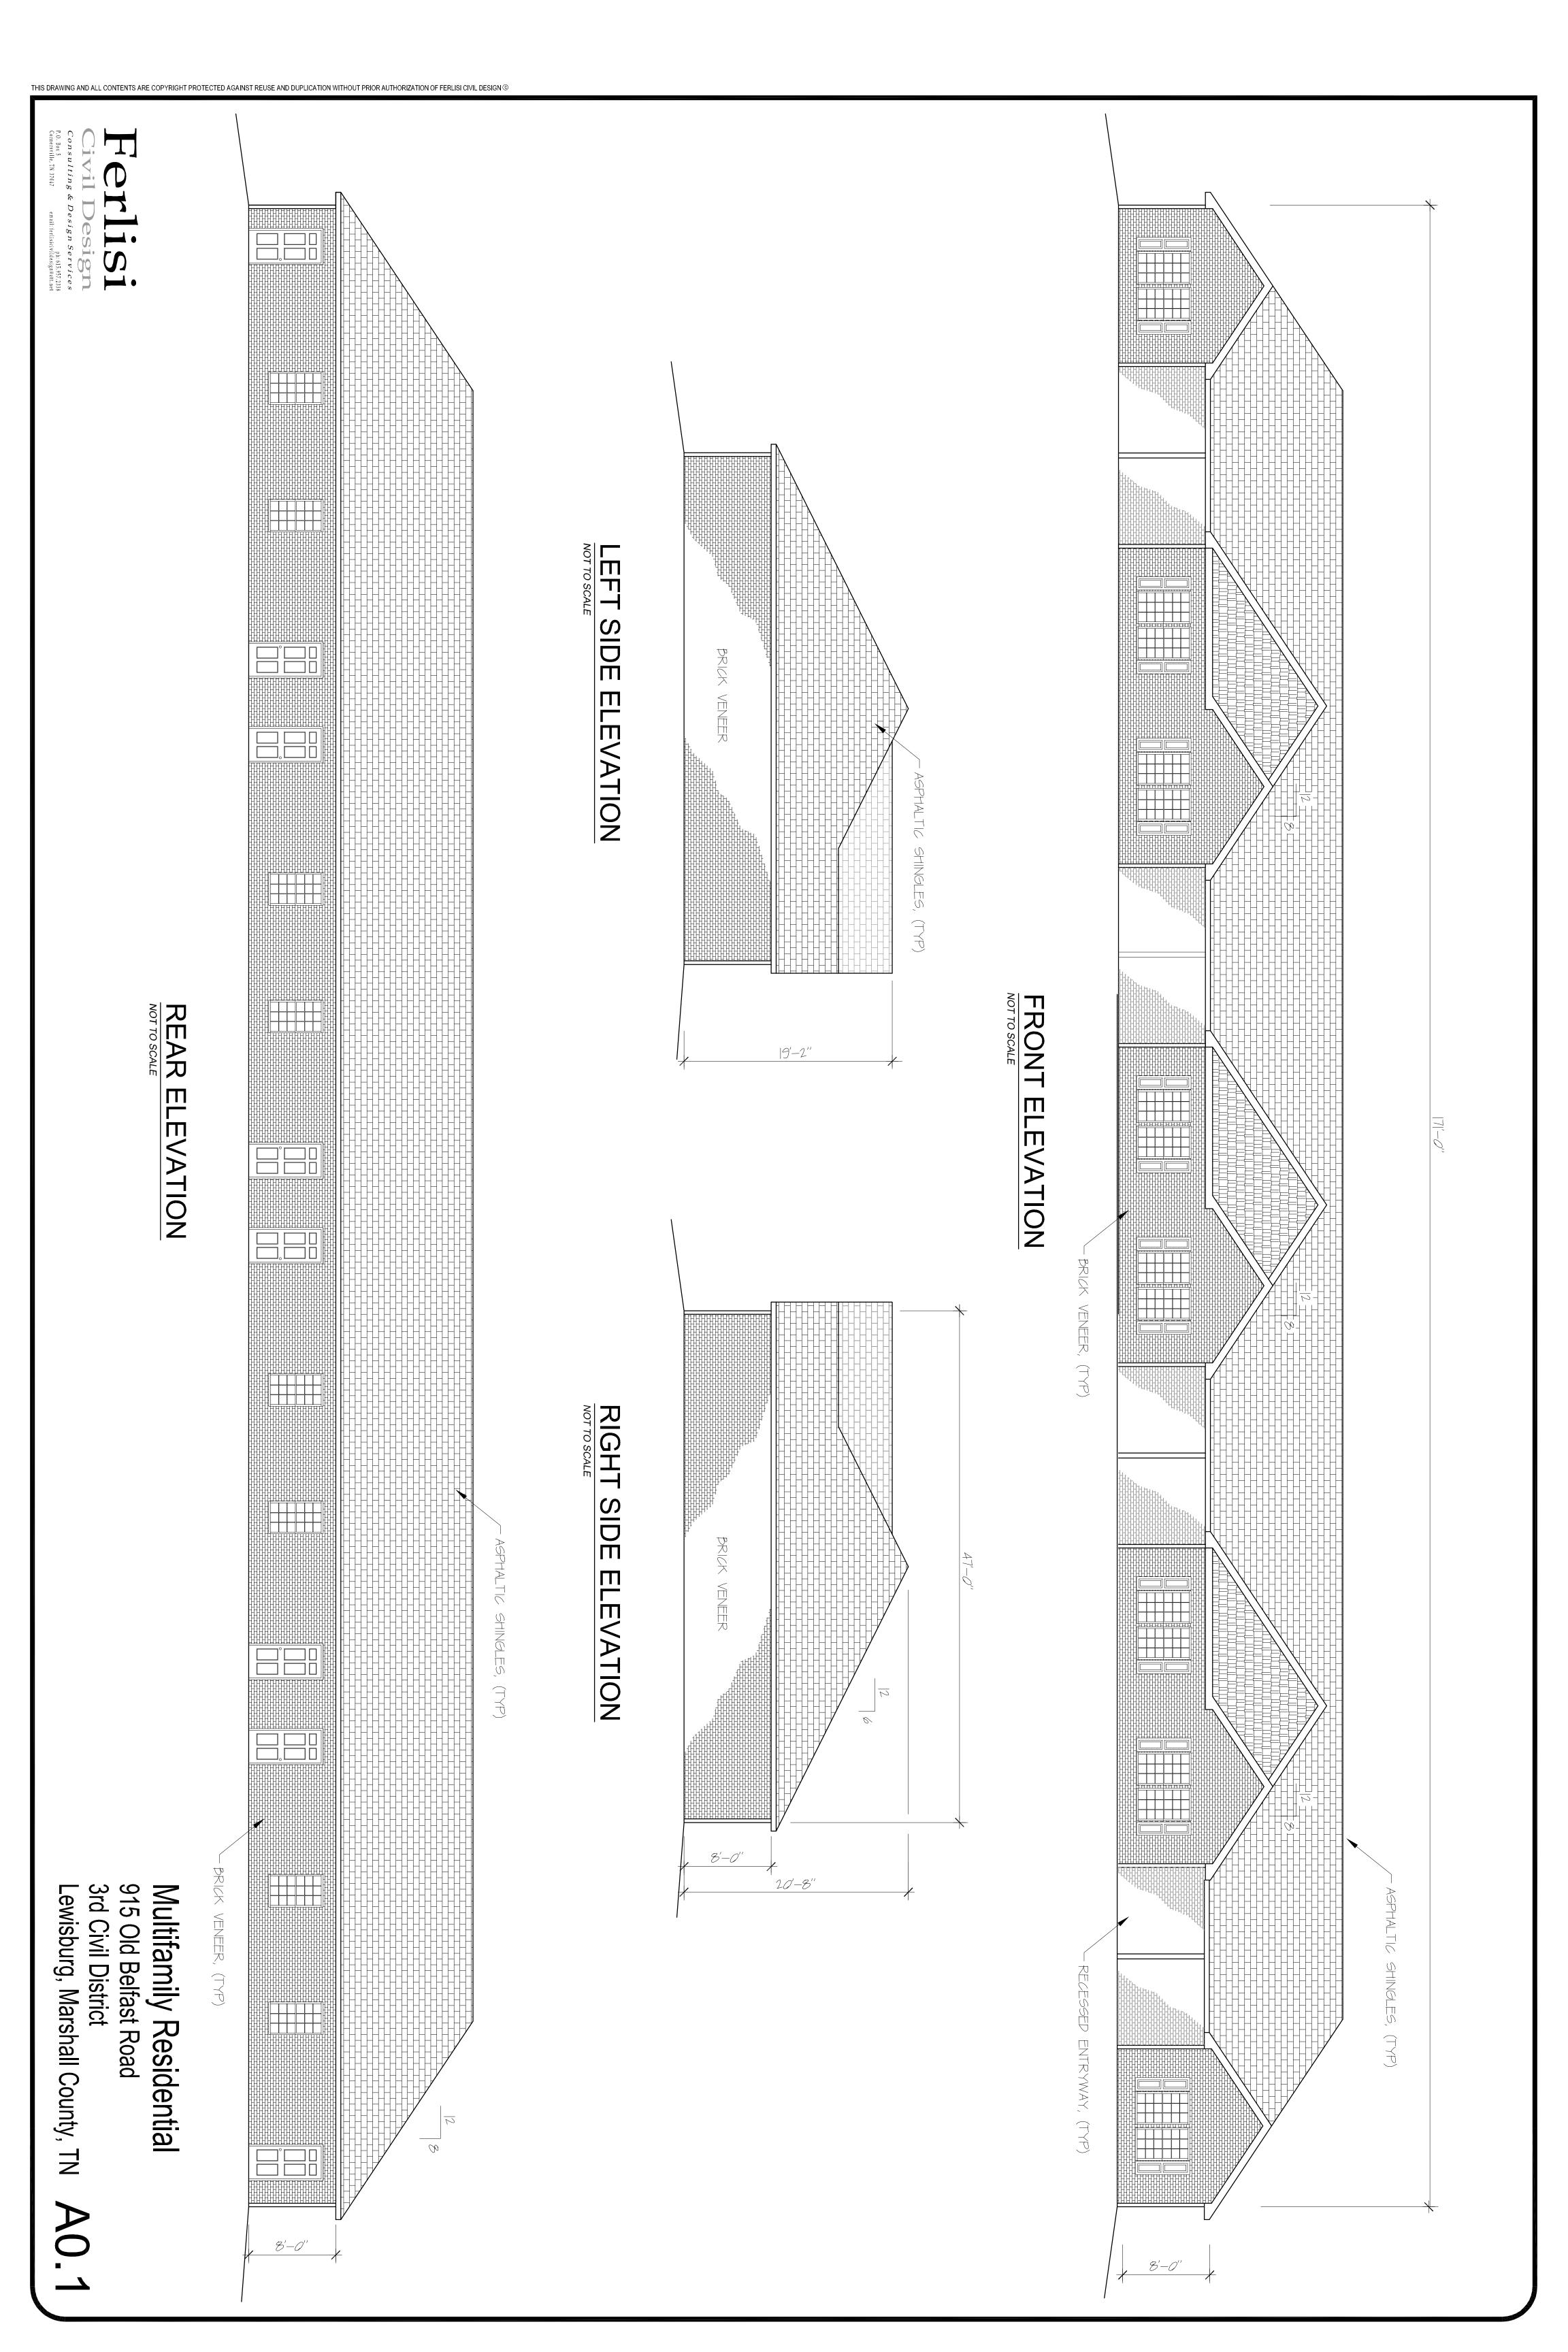

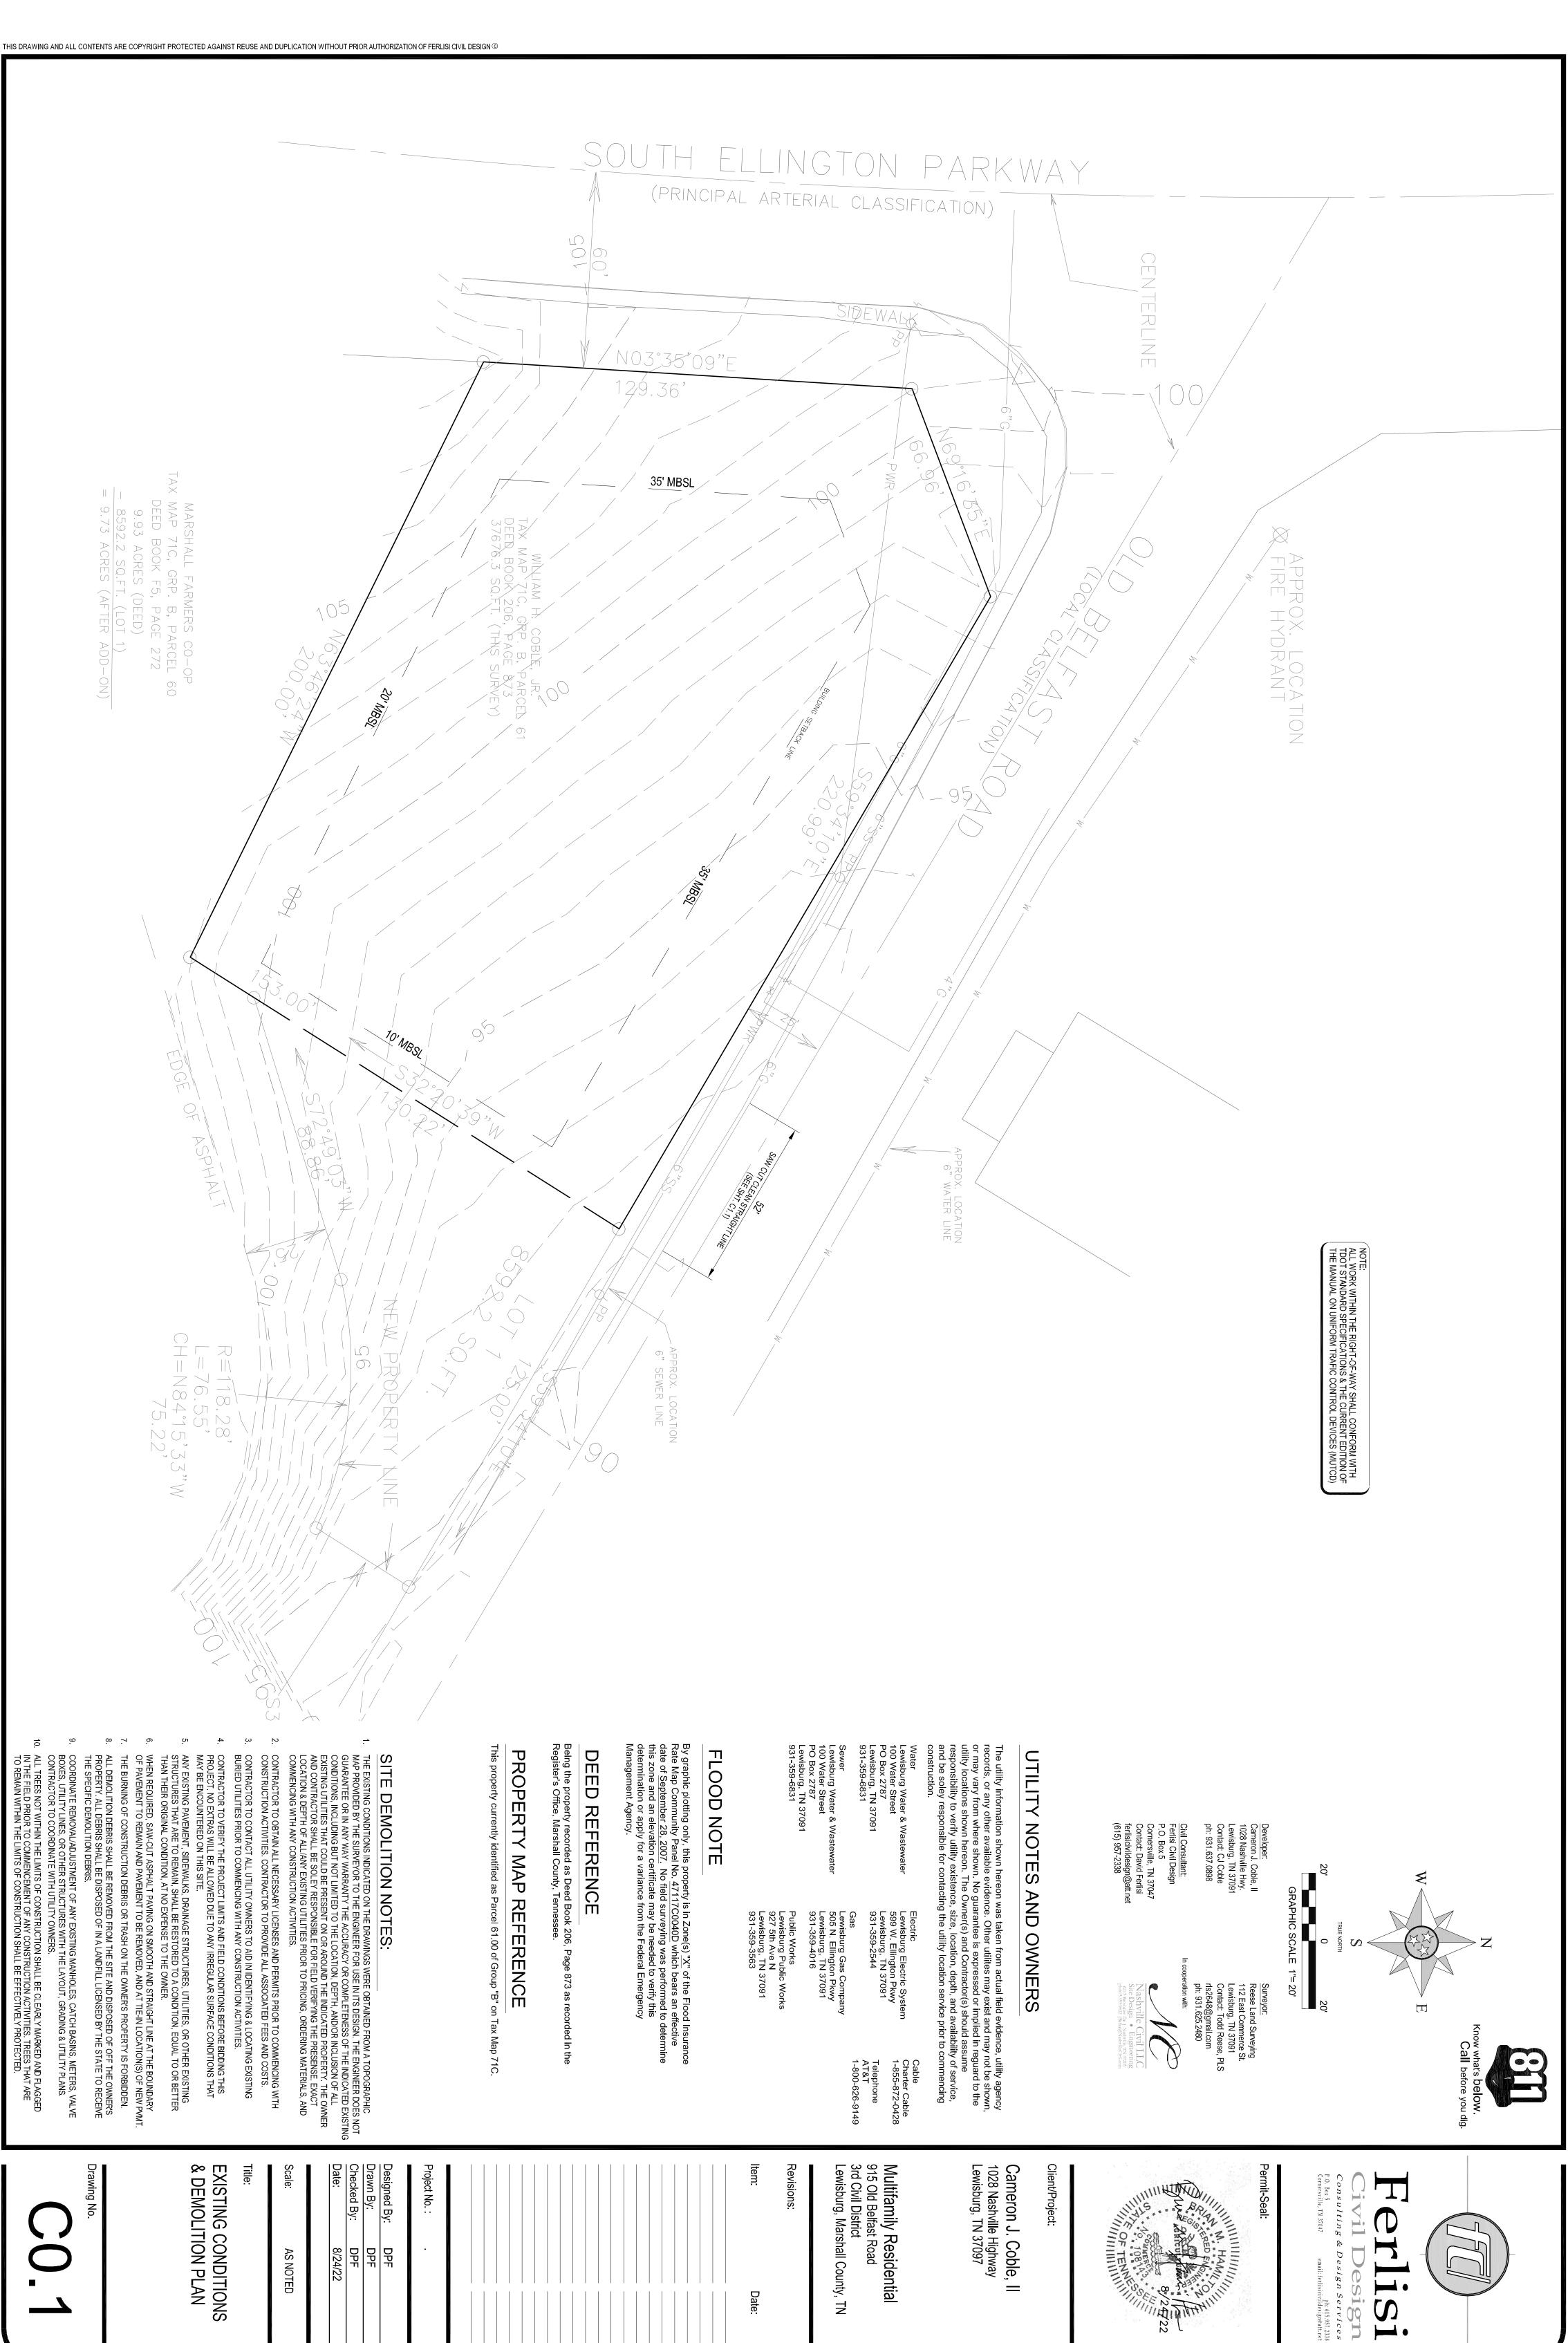

Date:

Design Se

DPF DPF DPF 8/24/22

AS NOTED

1. CONTRACTOR TO VERIFY ALL UTILITY ELEVATIONS, LOCATIONS, AND DEPTHS BEFORE BEGINNING CONSTRUCTION. THE OWNER DOES NOT ASSUME RESPONSIBILITY FOR THE POSSIBILITY THAT UTILITIES, OTHER THAN THOSE SHOWN MAY BE ENCOUNTERED OR THAT THE ACTUAL UTILITY LOCATIONS MAY BE DIFFERENT FROM THE LOCATIONS DESIGNATED ON THE CONTRACT DRAWINGS. THE CONTRACTOR SHALL, AT HIS OWN EXPENSE, FURNISH ALL LABOR AND TOOLS TO EITHER VERIFY AND SUBSTANTIATE OR DEFINITELY ESTABLISH THE UNDERGROUND UTILITY POSITIONS. CONTRACTOR TO CONTACT "TENNESSEE ONE CALL" A MINIMUM OF 48 HOURS RIOR TO BEGINNING ANY CONSTRUCTION ACTIVITIES TO AID IN IDENTIFYING ND LOCATING ANY EXISTING BURIED UTILITIES.

4. ALL EXISTING UTILITIES INCLUDING, VALVE(S) & BOXES, WATER & SEWER MAINS & SERVICES, METER BOXES, VAULTS, MANHOLES, UTILITY POLES, TELEPHONE PEDESTALS, ETC. WITHIN THE PROJECT LIMITS ARE TO BE ADJUSTED AS REQUIRED BY PROPOSED GRADING. THE CONTRACTOR SHALL BE RESPONSIBLE FOR CONTACTING AND COORDINATING WITH TDOT AND THE APPROPRIATE UTILITY OWNER(S). ALL CONSTRUCTION SHALL BE IN ACCORDANCE WITH THE APPROPRIATE UTILITY OWNER'S SPECIFICATIONS AND STANDARD DETAILS. THE ASSOCIATED COST OF UTILITIES ADJUSTMENT (REGARDLESS OF INDICATION ON THESE PLANS)SHALL BE THE RESPONSIBILITY OF THE CONTRACTOR. THE CONTRACTOR SHALL BE RESPONSIBLE FOR OBTAINING ALL/ANY ECESSARY LICENSE(S) AND PERMIT(S) PRIOR TO COMMENCING WITH ON-SITE ONSTRUCTION ACTIVITIES AS WELL AS REQUIRED TO PERFORM ANY ECESSARY UTILITY & GRADING WORK WITHIN THE STATE RIGHT-OF-WAY ONTRACTOR TO PROVIDE ALL ASSOCIATED FEES AND COSTS.

6. ANY WATER WORKS, MAINS, LATERALS, METERS OR OTHER PROPERTY THAT IS DAMAGED OR DESTROYED SHALL BE PROMPTLY REPLACED OR REPAIRED IN A SATISFACTORY MANNER EQUAL TO OR BETTER THAN IT'S PREVIOUS CONDITION. 5. ALL MATERIALS, INSTALLATION AND INSPECTION OF WATER AND/OR SANITARY SEWER MAINS, LATERALS AND APPURTENANCES SHALL MEET OR EXCEED THE MINIMUM LOCAL AND STATE REQUIREMENTS.

8. ANY MANHOLES NEEDING TO BE ADJUSTED TO FINAL GRADE SHALL BE BY BRICK AND MORTAR OR BY PRECAST EXTENSIONS; HOWEVER NO MANHOLE EXTENSION SHALL EXCEED MORE THAN 2-1/2 FEET OF CHIMNEY AS MEASURED FROM THE TOP OF THE MANHOLE RIM TO THE POINT WHERE THE MANHOLE STARTS TO INCREASE IN SIZE. 7. ANY FIRE HYDRANT THAT IS RELOCATED, RESET OR ADJUSTED SHALL NOT BE KEPT OUT OF SERVICE FOR MORE THAN 48 HOURS.

10. THE DEVELOPER SHALL BE RESPONSIBLE FOR ALL COSTS ASSOCIATED WITH WATER & SEWER TAPS AS REQUIRED BY LEWISBURG WATER & SEWER. 9. THE CONTRACTOR SHALL AT NO TIME ALLOW GROUND AND STORM WATER TO BE PUT INTO THE SANITARY SEWER MANHOLES, WATER MAINS AND LATERALS.

SITE **PARKING LOT**

(PRINCIPAL ARTERIAL CLASSIFICATION)

ROUTE OVERHEAD ELEC SERVICE TO — PROPOSED BLDG. (COORDINATE ROUTING/CONNECTION W/UTIL. OWNER)

2. PROVIDE PARKING LOT IN GOOD CONDITION, PROPERLY STRIPED WITH YELLOW PAINT. A MINIMUM OF (30) PARKING SPACES IS REQUIRED, INCLUDING A MINIMUM OF (2) HANDICAP ACCESSIBLE SPACES (UNLESS OTHERWISE INDICATED ON PLANS). HANDICAP SPACES SHALL BE PROPERLY MARKED, SIGNED, AND ADA COMPLIANT. 1. USE PARKING SPECIFICATIONS NOTED ELSEWHERE IN THESE PLANS UNLESS A CERTIFIED GEOTECH REPORT IS PROVIDED BY THE DEVELOPER WHICH SPECIFIES AN ALTERNATIVE REQUIREMENT.

N03°35'09"

 ∞

A'01

SAWCUT CLEAN STRAIGHT LINE

129.36

3. PROPER ACCESS FOR DOLLAR GENERAL'S FREIGHT TRUCKS (73'-0" TOTAL LENGTH) IS REQUIRED DURING NORMAL BUSINESS HOURS. TRUCK PATH TO BE FREE OF LANDSCAPE ISLANDS, SIGNS, LIGHT POLES, AND OTHER BARRIERS WHILE MAINTAINING WIDE RADIUS CURVES ON ALL ENTRANCES AND EXITS. HEAVY DUTY PAVING IS REQUIRED IN ALL TRAVELWAYS. 4. PROVIDE PROPER PROTECTION (BOLLARDS, GUARD RAILS, OR EQUIVALENT) FOR ELECTRIC, GAS, HVAC, AND WATER METERS THAT ARE IN POTENTIALLY HAZARDOUS LOCATIONS.

6. PROVIDE AND INSTALL CONCRETE SPLASH BLOCKS AT ALL UNPAVED DOWN SPOUT LOCATIONS. 5.CONTRACTOR WILL COMPLETE ALL SITE WORK, FINAL GRADING, LANDSCAPING, SEEDING, PAVING, STORM WATER DETENTION PONDS (WHEN REQUIRED), AND REMOVAL OF DEBRIS.

TAX MAP 710 DEED BOOK 3 37676.3 SQ.F

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9. EROSION CONTROL SHALL BE PROVIDED BY THE CONTRACTOR AS INDICATED ON THE STORM WATER POLLUTION PREVENTION PLAN(S) (SWPPP) PROVIDED IN THIS SET OF PLANS. SEE SWPPP FOR ALL EROSION CONTROL REQUIREMENTS.

10. THE DUMPSTER ENCLOSURE MUST BE A MINIMIUM OF 18' WIDE X 12' DEEP ENCLOSURE MATERIAL AS PER LOCAL REQUIREMENTS (AS REQUIRED).

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MARSHALL FARMERS CO-OP

X MAP 71C, GRP. B, PARCEL 60

DEED BOOK F5, PAGE 272


9.93 ACRES (DEED)

- 8592.2 SQ.FT. (LOT 1)

= 9.73 ACRES (AFTER ADD-ON)

7. ROUTE DOWN SPOUTS UNDER SIDEWALKS (SEE DETAILS) AT ALL SIDEWALK LOCATIONS.

8. NO PARKING STOPS SHALL BE PROVIDED IN FRONT OF OR DIRECTLY ADJACENT TO THE BUILDING. CURBING OR CONCRETE PARKING STOPS SHOULD BE LOCATED AT PERIMETER PARKING ZONES ONLY.

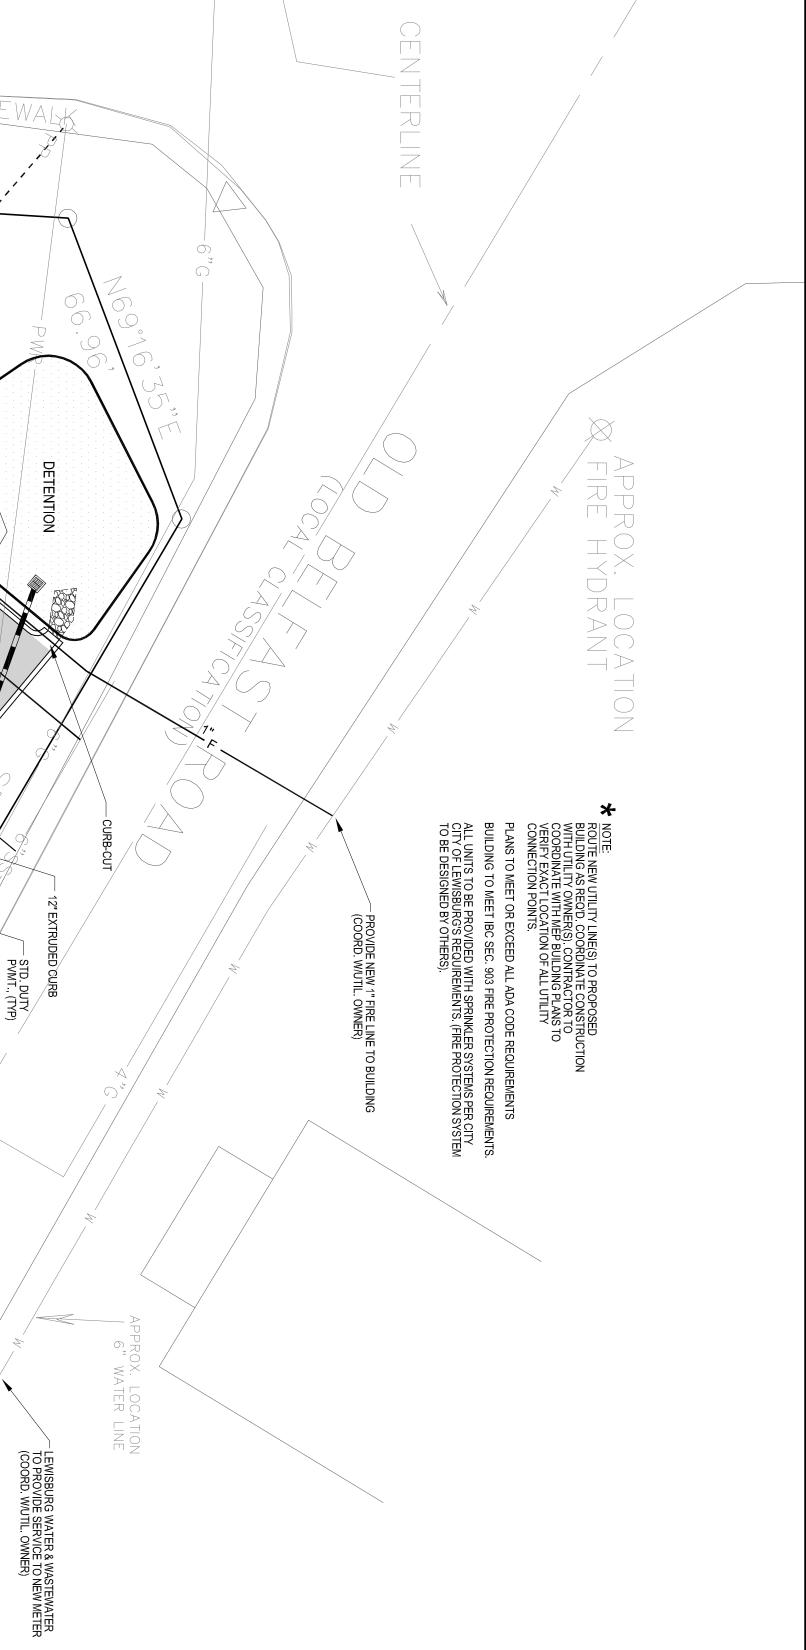

UTILITY NOTES AND OWNERS

Civil Consultant:
Ferlisi Civil Design
P.O. Box 5
Cornersville, TN 37047
Contact: David Ferlisi
ferlisicivildesign@att.net
(615) 957-2338

A CORRECTION BY 24/22

AGRICULTURE 8/24/22

Cameron J. Coble, II
1028 Nashville Hwy.
Lewisburg, TN 37091
Contact: CJ Coble
ph: 931.637.0898

Reese Land Surveying 112 East Commerce St. Lewisburg, TN 37091 Contact: Todd Reese, PLS rls2648@gmail.com ph: 931.625.2480

Permit-Seal:

P.O. Box 5 Cornersville, TN 37047

ivil

ad

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1028 Nashville Highway Lewisburg, TN 37097

Cameron J. Coble, II

Client/Project:

ROUTE SEWER TO EX. 6" SEWER LINE (FIELD LOCATE)

Lewisburg Water & Waste 100 Water Street PO Box 2787 Lewisburg, TN 37091 931-359-6831 Lewisburg Water & Waster 100 Water Street PO Box 2787 Lewisburg, TN 37091 931-359-6831 Lewisburg Electric System 599 W. Ellington Pkwy Lewisburg, TN 37091 931-359-2544 Lewisburg Gas Company 505 N. Ellington Pkwy Lewisburg, TN 37091 931-359-4016 Public Works
Lewisburg Public Works
927 5th Ave N
Lewisburg, TN 37091
931-359-3563 Telephone AT&T 1-800-626-9149

Multifamily Residential 915 Old Belfast Road 3rd Civil District Lewisburg, Marshall County, TN

Revisions

Date:

FLOOD NOTE

By graphic plotting only, this property is in Zone(s) "X" of the Flood Insurance Rate Map Community Panel No. 47117C0040D which bears an effective date of September 28, 2007. No field surveying was performed to determine this zone and an elevation certificate may be needed to verify this determination or apply for a variance from the Federal Emergency Management Agency.

DEED REFERENCE

Being the property recorded as Deed Book 206, Page Register's Office, Marshall County, Tennessee. PROPERTY MAP REFERENCE 873

RETAINING WALL

HANDICAP PARKING (VAN ACCESSIBLE)

FOR SERVICE

1 1/2" MASTER METER

10'x10' SCREENED DUMPSTER FACILITY

SITE LAYOUT NOTES:

1. DIMENSIONS INDICATED ON PLANS ARE TO FACE OF CURB, EDGE OFSIDEWALK, OUTSIDE FACE OF BUILDING, OR EDGE OF PAVEMENT UNLESS OTHERWISE INDICATED ON PLAN

4. ALL TRAFFIC SIGNS ARE TO BE REFLECTIVE) COMPLIANT WITH CURRENT "MANUAL ON UNIFORM TRAFFIC CONTROL DEVICES" (MUTCD) AND SHALL COMPLY WITH TDOT REQUIREMENTS. 3. SCORE SIDEWALKS TRANSVERSELY AT SPACINGS EQUAL TO WIDTH UNLESS INDICATED OTHERWISE ON PLANS. 1/2" EXPANSION JOINTS SHALL BE SPACED AT MAXIMUM OF 40 FEET O.C. AT POINTS WHERE THE SIDEWALK ABUTS OTHER STRUCTURES AND/OR AS INDICATED ON THE PLANS. . ALL COORDINATES (IF SHOWN) & BEARINGS ARE BASED ON AN ASSUMED OORDINATE SYSTEM UNLESS OTHERWISE NOTED.

UNLESS OTHERWISE INDICATED ON PLANS, ALL PAINTED STANFDARD PARKING PACES & ISLAND STRIPING SHALL FOR ASPHALT & CONCRETE PAVEMENT SHALL BE EFLECTIVE TYPE, COLOR: YELLOW. ALL ADA ACCESSIBLE PARKING SPACES AND YMBOLS SHALL BE REFLECTIVE TYPE, COLOR: "HC" BLUE. BOLLARDS SHALL BE EFLECTIVE TYPE, COLOR: YELLOW. STOP BARS AND TRAFFIC MARKINGS SHALL BE EFLECTIVE TYPE, COLOR: WHITE. TRAFFIC LANE STRIPING BETWEEN EXIT LANES HALL BE 4" REFLECTIVE TYPE, COLOR: WHITE. TRAFFIC LANE STRIPING BETWEEN.

6. PAINTED FIRE LANE STRIPING OR PAINTED CURBS SHALL BE PROVIDED AS REQUIRED BY LOCAL JURISDICTIONAL REQUIREMENTS. 7. THE CONTRACTOR SHALL TAKE ALL NECESSARY PRECAUTIONS TO AVOID DAMAGE TO ADJACENT PROPERTIES & EXISTING UTILITIES DURING CONSTRUCTION AND SHALL BE HELD SOLEY RESPONSIBLE FOR ANY AND ALL DAMAGES THAT MAY OCCUR DURING CONSTRUCTION ACTIVITIES.

9. SURPLUS MATERIAL NOT REQUIRED TO COMPLETE SITE CONSTRUCTION SHALL BE FIRST OFFERED TO THE OWNER. SURPLUS MATERIAL NOT ACCEPTED BY THE OWNER SHALL THEN BE DISPOSED OF BY THE CONTRACTOR AT HIS OWN EXPENSE FOLLOWING OWNER'S APPROVAL. 3. THE CONTRATOR SHALL BE HELD SOLEY RESPONSIBLE FOR JOB SITE CONDITIONS, NCLUDING SAFETY OF ALL PERSONS AND PROPERTY DURING DURATION OF CONSTRUCTION. THIS REQUIREMENT SHALL APPLY CONTINUOUSLY AND IS NOT LIMITED TO NORMAL WORKING HOURS.

SITE LAYOUT & UTILITY PLAN


Title:

Designed By:
Drawn By:
Checked By: Project No.: PF PF PPF

scale:	
AS NOTED	

Drawing No.

10. PROVISIONS FOR LOCAL LANDSCAPING REQUIREMENTS, INCLUDING LANDSCAPING IRRIGATION, ARE NOT SHOWN (UNLESS INCLUDED IN SCOPE) ON THESE PLANS. THE DEVELOPER IS ULTIMATELY RESPONSIBLE FOR PROVIDING LANDSCAPING PLANS IN ACCORDANCE WITH ANY LOCAL CODE REQUIREMENTS AS REQ'D.

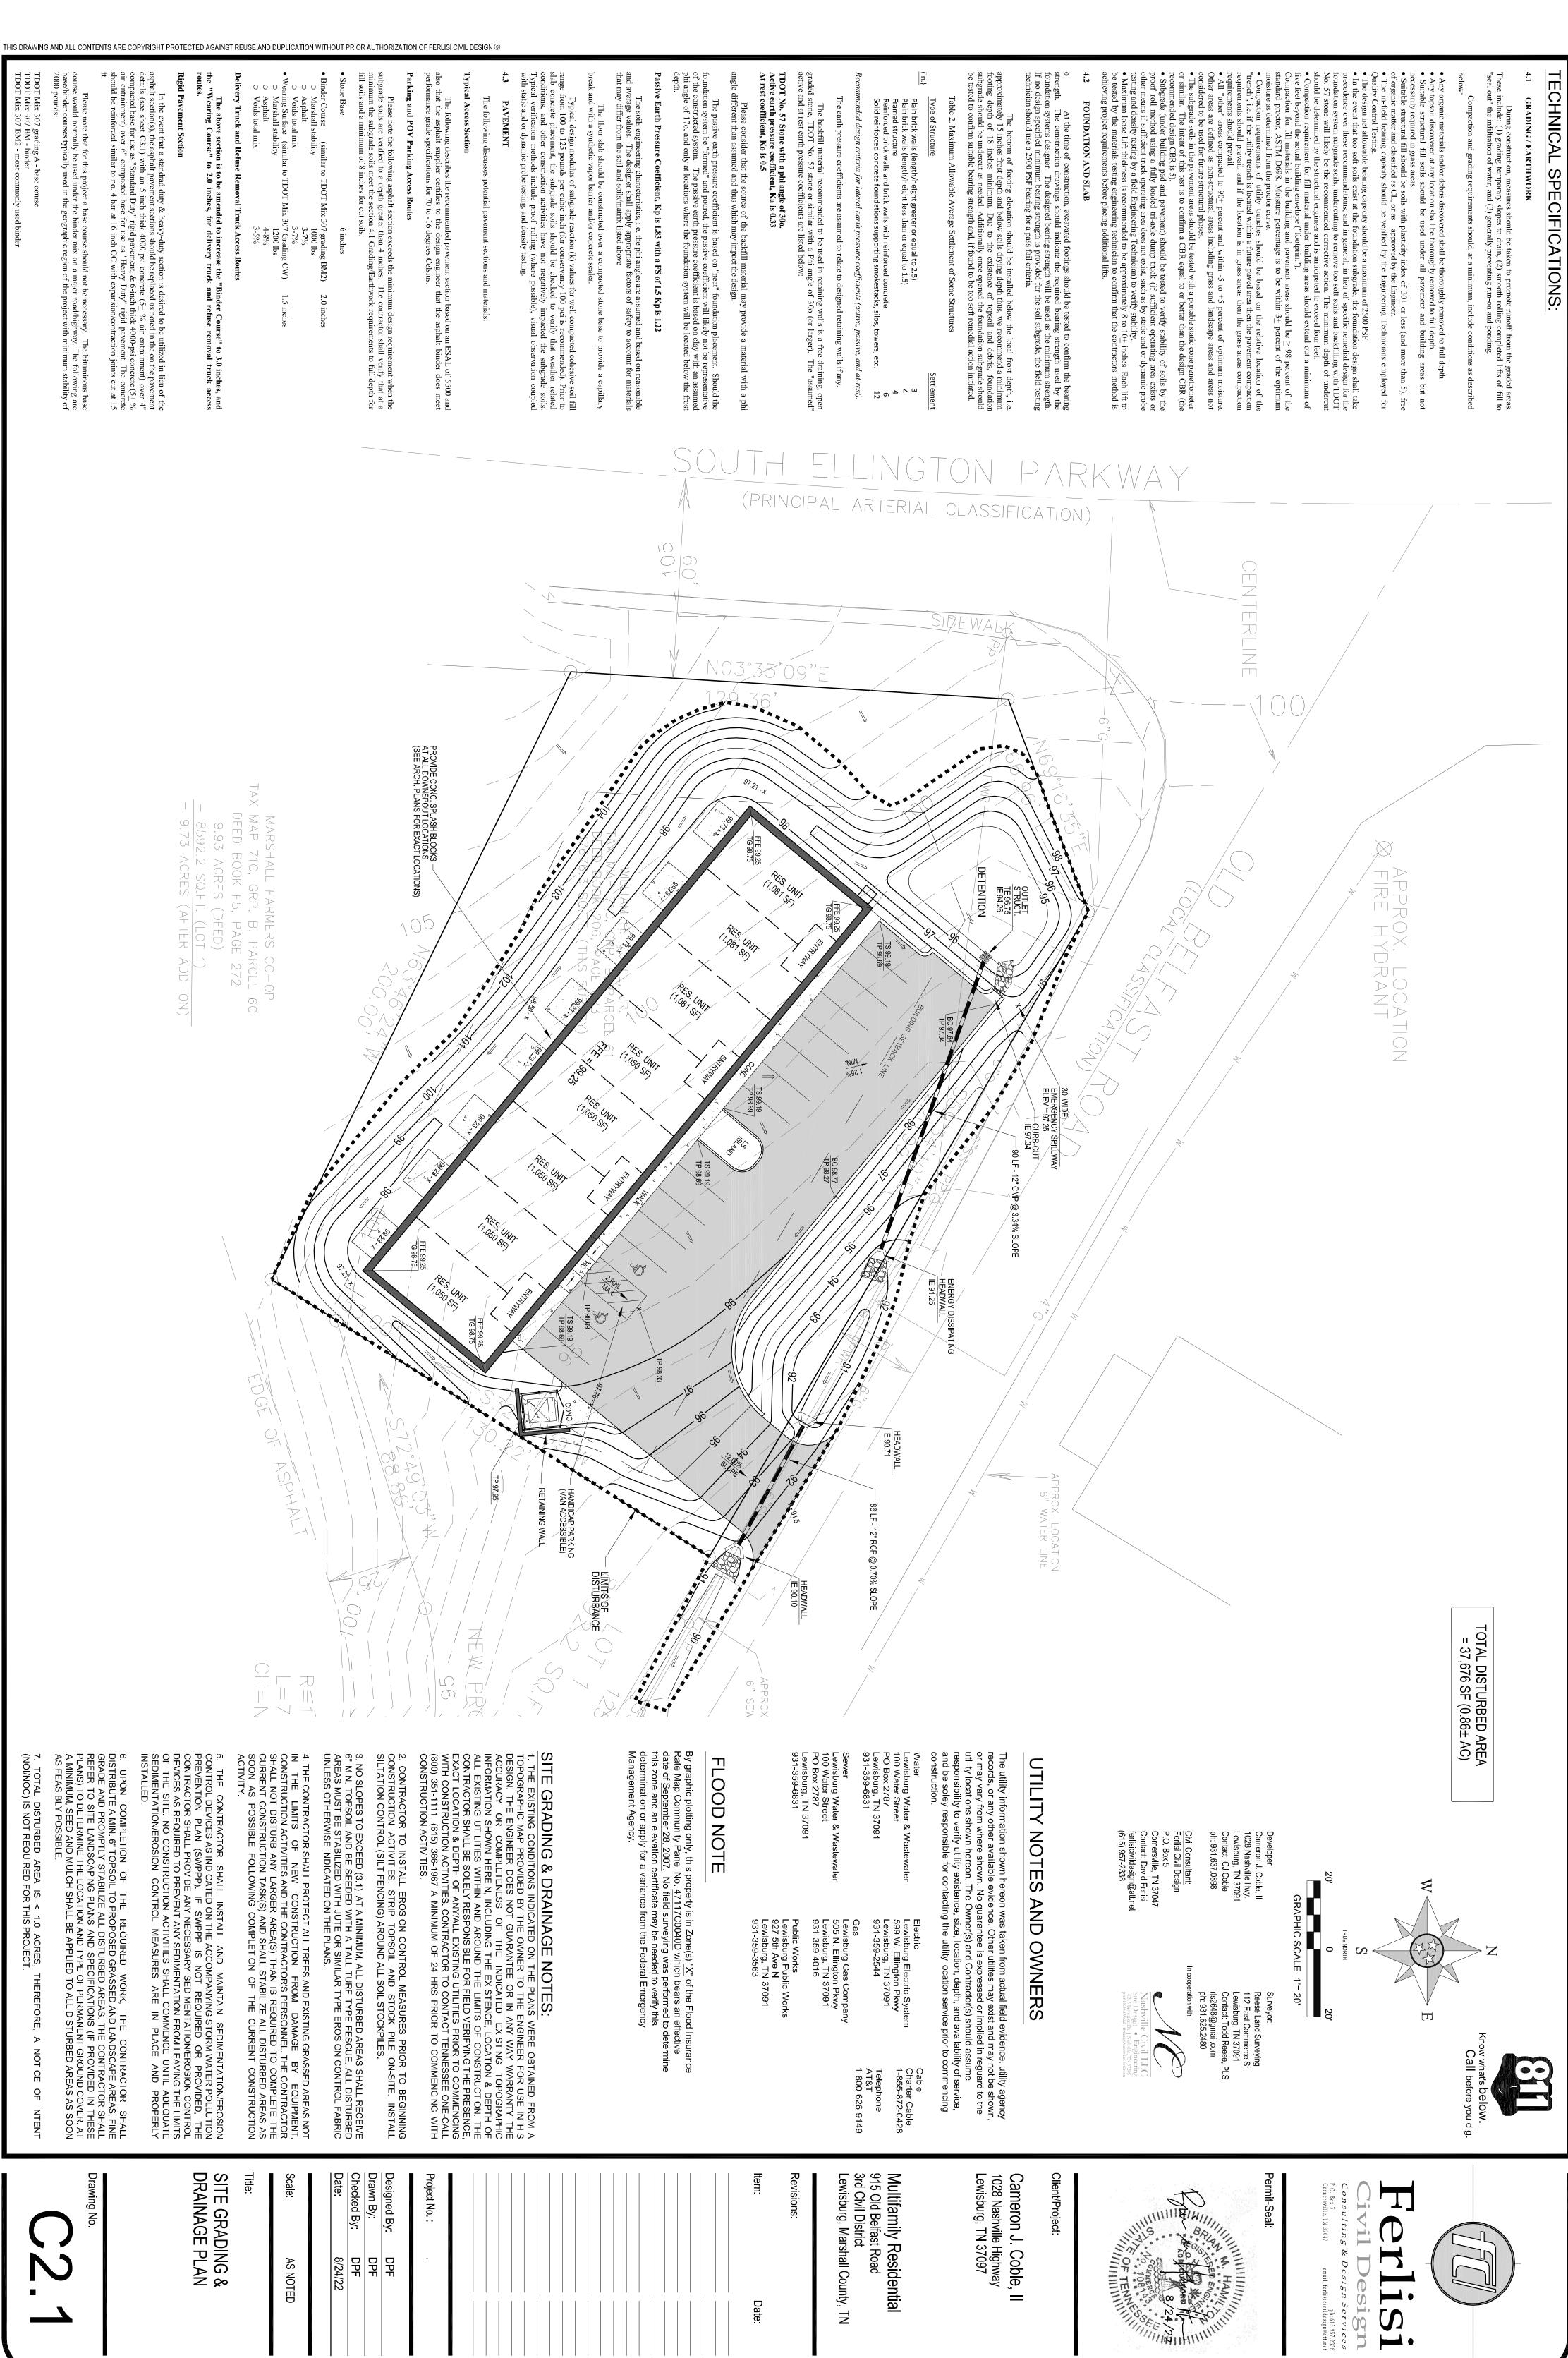

Date:

TOTAL DISTURBED AREA = 37,676 SF $(0.86\pm$ AC) - OUTLET PROTECTION - CONCRETE WASHOUT - TEMP. CONSTRUCTION ENTRANCE SWPPP LEGEND





Permit-Seal:



HAMILLIAN HAMILL

Client/Project:

Cameron J. Coble,

UTILITY

NOTES AND OWNERS

1028 Nashville Highway Lewisburg, TN 37097

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Multifamily Residential 915 Old Belfast Road 3rd Civil District Lewisburg, Marshall County, TN

Revisions

Date:

By graphic plotting only, this property is in Zone(s) "X" of the Flood Insurance Rate Map Community Panel No. 47117C0040D which bears an effective date of September 28, 2007. No field surveying was performed to determine this zone and an elevation certificate may be needed to verify this determination or apply for a variance from the Federal Emergency Management Agency.

FLOOD NOTE

Being the property recorded as Deed Book 206, Page 873 as recor Register's Office, Marshall County, Tennessee.

DEED REFERENCE

PROPERTY MAP REFERENCE

rently identified as Par

cel 61.00 of Gro

ıp "B" on Tax Map 71C.

SITE GRADING & DRAINAGE NOTES:

1. THE EXISTING CONDITIONS INDICATED ON THE PLANS WERE OBTAINED FROM A TOPOGRAPHIC M PROVIDED BY THE OWNER TO THE ENGINEER FOR USE IN HIS DESIGN. THE ENGINEER DOES NOT GUARANTEE OR IN ANY WAY WARRANTY THE ACCURACY OR COMPLETENESS OF THE INDICATED EXISTING TOPOGRAPHIC INFORMATION SHOWN HEREIN, INCLUDING THE EXISTENCE, LOCATION & DEPTH OF ALL EXISTING UTILITIES WITHIN AND AROUND THE LIMITS OF CONSTRUCTION. THE CONTRACTOR SHALL BE SOLELY RESPONSIBLE FOR FIELD VERIFYING THE PRESENCE, EXACT LOCATION & DEPTH OF ANY/ALL EXISTING UTILITIES PRIOR TO COMMENCING WITH CONSTRUCTION ACTIVITIES. CONTRACTOR TO CONTACT TENNESSEE ONE-CALL (800) 351-1111, (615) 366-1967 A MINIMUM OF 24 HRS PRIOR TO COMMENCING WITH CONSTRUCTION ACTIVITIES.

Designed By Project No

Drawn By: Checked By: DPF DPF DPF 8/24/22

Scale: AS NOTED

INITIAL STORM WATER POLLUTION PROTECTION PLAN (SWPPP)

4. THE CONTRACTOR SHALL PROTECT ALL TREES AND EXISTING GRASSED AREAS NOT IN THE LIMITS OF NEW CONSTRUCTION FROM DAMAGE BY EQUIPMENT, CONSTRUCTION ACTIVITIES AND THE CONTRACTOR'S PERSONNEL. THE CONTRACTOR SHALL NOT DISTURB ANY LARGER AREA(S) THAN IS REQUIRED TO COMPLETE THE CURRENT CONSTRUCTION TASK(S) AND SHALL STABILIZE ALL DISTURBED AREAS AS SOON AS POSSIBLE FOLLOWING COMPLETION OF THE CURRENT CONSTRUCTION ACTIVITY.

Title

THE CONTRACTOR SHALL INSTALL AND MAINTAIN SEDIMENTATION/EROSION CONTROL DEVICES AS IDICATED ON THE ACCOMPANYING STORM WATER POLLUTION PREVENTION PLAN (SWPPP). IF WPPP IS NOT REQUIRED OR PROVIDED, THE CONTRACTOR SHALL PROVIDE ANY NECESSARY EDIMENTATION/EROSION CONTROL DEVICES AS REQUIRED TO PREVENT ANY SEDIMENTATION FROM EAVING THE LIMITS OF THE SITE. NO CONSTRUCTION ACTIVITIES SHALL COMMENCE UNTIL DEQUATE SEDIMENTATION/EROSION CONTROL MEASURES ARE IN PLACE AND PROPERLY ISTALLED.

3. NO SLOPES TO EXCEED (3:1), AT A MINIMUM, ALL DISTURBED AREAS SHALL RECEIVE 6" MIN. TOPSOIL AND BE SEEDED WITH A TALL TURF TYPE FESCUE. ALL DISTURBED AREAS MUST BE STABILIZED WITH JUTE OR SIMILAR TYPE EROSION CONTROL FABRIC UNLESS OTHERWISE INDICATED ON THE PLANS.

2. CONTRACTOR TO INSTALL EROSION CONTROL MEASURES PRIOR TO BEGINNING CONSTRUCTION ACTIVITIES. STRIP TOPSOIL AND STOCK PILE ON-SITE. INSTALL SILTATION CONTROL (SILT FENCING) AROUND ALL SOIL STOCKPILES.

6. UPON COMPLETION OF THE REQUIRED WORK, THE CONTRACTOR SHALL DISTRIBUTE A MIN. 6" TOPSOIL TO PROPOSED GRASSED AND LANDSCAPE AREAS, FINE GRADE AND PROMPTLY STABILIZE ALL DISTURBED AREAS. THE CONTRACTOR SHALL REFER TO SITE LANDSCAPING PLANS AND SPECIFICATIONS (IF PROVIDED IN THESE PLANS) TO DETERMINE THE LOCATION AND TYPE OF PERMANENT GROUND COVER. AT A MINIMUM, SEED AND MULCH SHALL BE APPLIED TO ALL DISTURBED AREAS AS SOON AS FEASIBLE POSSIBLE.

7. TOTAL DISTURBED AREA IS < 1.0 ACRES, THEREFORE, A NOTICE OF REQUIRED FOR THIS PROJECT.

INTENT (NOI/NOC) IS NOT

EXTRA MEASURES MAY BE NEEDED IF SITE:
- IS WITHIN 300 FEET OF A STREAM OR WETLAND
- IS WITHIN 1000 FEET OF A LAKE
- IS STEEP SLOPE (SLOPE OF 12 % OR GREATER)
- RECEIVES RUNOFF FROM 10,000 SQ.FT. OR MORE
OF ADJACENTLAND
- HAS MORE THAN AN ACRE OF DISTURBED GROUND **GENERAL NOTES:**

PRESERVING EXISTING VEGETATION:
- WHENEVER POSSIBLE, PRESERVE EXISTING
TREES, SHRUBS, AND OTHER VEGETATION TO
PREVENT ROOT DAMAGE DO NOT GRADE, PLACE
SOIL PILES, OR PARK VEHICLES NEAR TREES
MARKED FOR PRESERVATION.

DOWNSPOUT EXTENDERS:

- NOT REQUIRED BUT HIGHLY RECOMMENDED

- INSTALL AS SOON AS GUTTERS AND DOWNSPOUTS
ARE COMPLETED

- ROUTE WATER TO GRASSED AREA

- MAINTAIN UNTIL LAWN IS ESTABLISHED REVEGETATION:
- DISTURBED SOILS SHALL BE STABILIZED AS QUICK AS PRACTICAL WITH TEMPORARY VEGETATION AND OFR MULCHING TO PROTECT EXPOSED CRITICAL AREAS DURING DEVELOPMENT.
TEMPORARY MULCH IS TO BE APPLIED AT THE RATE OF 2-3 BALES STRAW PER 1000 SQ. FT.

POST CONSTRUCTION SLOPE STABILIZATION:
3:1 SLOPES SHOWN HEREON TO BE SODDED FOR
STABILIZATION. (UNLESS NOTED OTHERWISE)
2:1 SLOPES SHOWN HEREON TO BE STABILIZED
WITH NORTH AMERICAN GREEN SC150 EROSION
CONTROL BLANKET OR APPROVED SUBSTITUTE
STAPLE PATTERN "D":

1. THE CONTRACTOR SHALL COMPLY WITH ALL LOCAL & STATE STORMWATER ORDINANCES FOR GRADING AND EROSION AND SEDIMENT CONTROL FOR THE MEASURES SHOWN OR STATED ON THESE PLANS. **ROSION &** SEDIMENT CONTROL NOTES:

2. CONTRACTOR MUST ENSURE THAT THE CONSTRUCTION SITE IS PREPARED PRIOR TO THE ONSET OF ANY STORM. CONTRACTOR SHALL HAVE ALL EROSION AND SEDIMENT CONTROL MEASURES IN PLACE PRIOR TO COMENCING WITH CONSTRUCTION ACTIVITIES.

3. ALL EROSION AND SEDIMENT CONTROL MEASURES SHALL BE MAINTAINED UNTIL DISTURBED AREA ARE STABILIZED. CHANGES TO THIS EROSION AND SEDIMENT CONTROL PLAN SHALL BE MADE TO MEET FIELD CONDITIONS AS REQUIRED TO PREVENT EROSION & SEDIMENT FROM LEAVING THE LIMITS OF THE PROPERTY.

(PRINCIPAL ARTERIAL CLASSIFICATION)

DETENTION

ALL DISTURBED AREAS, DITCHES, & SLOPES TO RECEIVE SEED IMPREGNATED GEOGRID MATTING OR SOLID SOD (TYP)

ENERGY DISSIPATING HEADWALL

OUTLET STRUCT.

30' WIDE / SPILLWAY

4. THIS PLAN MAY NOT COVER ALL THE SITUATIONS THAT ARISES DURING CONSTRUCTION DUE TO UNANTICIPATED FIELD CONDITIONS. VARIATIONS MAY BE MADE TO THE PLAN IN THE FIELD SUBJECT TO THE APPROVAL OF OR AT THE DIRECTION OF A REPRESENTATIVE OF THE DEPARTMENT OF UTILITIES. ALL EROSION AND SEDIMENT CONTROL MEASURES SHALL BE CHECKED EFORE AND AFTER ALL STORMS TO INSURE MEASURES ARE FUNCTIONING ROPERLY.

6. CONTRACTOR SHALL MAINTAIN A LOG AT SITE OF ALL INSPECTIONS OF MAINTENANCE OF BMP'S AS WELL AS ANY CORRECTIVE CHANGES TO THE BMP'S OR EROSION AND SEDIMENT CONTROL PLAN & SHALL OTHERWISE COMPLY WITH ALL TDEC REQUIREMENTS FOR TNEPSC.

7. IN AREAS WHERE SOIL IS EXPOSED PROMPT REPLANTING WITH NATIVE COMPATIBLE DROUGHT-RESISTANT VEGETATION SHALL BE PERFORMED. AREAS WILL BE LEFT EXPOSED OVER THE WINTER SEASON.

12/9.36

THE CONTRACTOR SHALL INSTALL THE STABILIZED CONSTRUCTION UTRANCE PRIOR TO COMMENCEMENT OF GRADING. LOCATION OF THE VITRANCE MAY BE ADJUSTED BY THE CONTRACTOR TO FACILITATE RADING OPERATIONS. ALL CONSTRUCTION TRAFFIC ENTERING THE PAVED OAD MUST CROSS THE STABILIZED CONSTRUCTION ENTRANCE. THE TABILIZED CONSTRUCTION ENTRANCE. THE TABILIZED CONSTRUCTION ENTRANCE. THE DAD BASE ROCK COURSE IS COMPLETE.

9. ALL SEDIMENT DEPOSITED ON PAVED ROADWAYS SHALL BE SWEPT AT THE END OF EACH WORK DAY OR AS NECESSARY.

10. CONTRACTOR SHALL PLACE EROSION CONTROL MEASURES AROUND ALL NEW DRAINAGE STRUCTURE OPENINGS IMMEDIATELY AFTER THE STRUCTURE OPENING IS CONSTRUCTED. THE EROSION CONTROL MEASURES SHALL BE MAINTAINED AND REMAIN PLACE UNTIL CONSTRUCTION IS COMPLETE.

11. CONTRACTOR SHALL IMPLEMENT HOUSEKEEPING PRACTICES AS FOLLOWS:

A. CONCRETE WASTE:
A. CONCRETE WASTE:
PROVIDE A DESIGNATED AREA FOR A TEMPORARY PIT TO BE USED FOR CONCRETE TRUCK WASH-OFF. DISPOSE OF HARDENED CONCRETE OFFSITE. AT NO TIME SHALL A CONCRETE TRUCK DUMP ITS WASTE AND CLEAN ITS TRUCK INTO THE CITY STORM DRAINS VIA CURB AND GUTTER. INSPECT DAILY TO CONTROL RUNOFF AND WEEKLY FOR REMOVAL OF HARDENED CONCRETE.

B. PAINT AND PAINTING SUPPLIES:
PROVIDE INSTRUCTION TO EMPLOYEES AND SUBCONTRACTORS REGARDING REDUCTION OF POLLUTANTS MATERIAL STORAGE USE AND CLEAN UP. INSPECT SITE WEEKLY FOR EVIDENCE OF IMPROPER DISPOSAL.

12. STABILIZATION MEASURES MUST BE INITIATED WITHIN SEVEN (7) DAYS ON PORTIONS OF THE SITE WHERE CONSTRUCTION ACTIVITIES HAVE TEMPORARILY OR PERMANENTLY CEASED, AND WITHIN (15) DAYS AFTER GRADING OF OTHER EARTHWORK. PERMANENT STABILIZATION WITH PERENNIAL VEGETATION (USE OF NATIVE-HERBACEOUS AND WOODY PLANTS WHERE PRACTICAL) OR OTHER PERMANENTLY STABLE, NON-ERODING SURFACE SHALL REPLACE ANY TEMPORARY MEASURES AS SOON AS IT IS PRACTICAL. STABILIZATION PRACTICES MAY INCLUDE: TEMPORARY SEEDING, PERMANENT SEEDING, MULCHING, GEO-TEXTILES, SOD STABILIZATION AND OTHER APPROPRIATE MEASURES. RY MEASURES AS Y INCLUDE:
GEO-TEXTILES,

13. STRUCTURAL PRACTICES TO DIVERT FLOWS FROM AREAS OF LAND DISTURBANCE, STORE FLOWS OR OTHERWISE LIMIT RUNOFF AND THE DISCHARGE OF POLLUTANTS FROM EXPOSED AREAS OF THE SITE MUST BE IMPLEMENTED. SUCH PRACTICES MAY INCLUDE SILT FENCES, EARTH DIKES, DRAINAGE SWALES, SEDIMENT TRAPS, CHECK DAMS, SURFACE DRAINS, PIPE SLOPE DRAINS, STORM DRAIN INLET PROTECTION, ROCK OUTLET PROTECTION, REINFORCED SOIL RETAINING SYSTEMS AND GABIONS.

3 ACRES (ULL, 2.2 SQ.FT. (LOT 1) ^CRES (AFTER ADD-ON)

L FARMERS CO-OP, GRP. B, PARCEL 60 OK F5, PAGE 272 ORES (DEED)

ASPHAL

4. THE CONTRACTOR SHALL PROTECT ALL TREES AND EXISTING GRASSED AREAS NOT IN THE LIMITS OF NEW CONSTRUCTION FROM DAMAGE BY EQUIPMENT, CONSTRUCTION ACTIVITIES AND THE CONTRACTOR'S PERSONNEL. THE CONTRACTOR SHALL NOT DISTURB ANY LARGER AREA(S) THAN IS REQUIRED TO COMPLETE THE CURRENT CONSTRUCTION TASK(S) AND SHALL STABILIZE ALL DISTURBED AREAS AS SOON AS POSSIBLE FOLLOWING COMPLETION OF THE CURRENT CONSTRUCTION ACTIVITY.

3. NO SLOPES TO EXCEED (3:1), AT A MINIMUM, ALL DISTURBED AREAS SHALL RECEIVE 6" MIN. TOPSOIL AND BE SEEDED WITH A TALL TURF TYPE FESCUE. ALL DISTURBED AREAS MUST BE STABILIZED WITH JUTE OR SIMILAR TYPE EROSION CONTROL FABRIC UNLESS OTHERWISE INDICATED ON THE PLANS.

2. CONTRACTOR TO INSTALL EROSION CONTROL MEASURES PRIOR TO BEGINNING CONSTRUCTION ACTIVITIES. STRIP TOPSOIL AND STOCK PILE ON-SITE. INSTALL SILTATION CONTROL (SILT FENCING) AROUND ALL SOIL STOCKPILES.

14. INSPECTION OF ALL CONTROL MEASURES AND DISTURBED AREAS MUST BE PERFORMED BY A TDEC LEVEL ONCE CERTIFIED INSPECTOR TWICE PER WEEK, AT LEAST 72 HOURS APART, AND BEFORE ANTICIPATED STORM EVENTS (OR SERIES OF STORM EVENTS SUCH AS INTERMITTENT SHOWS OVER ONE OR MORE DAYS) AND 24 HOURS AFTER THE END OF A STORM EVENT 0.5 INCHES OR GREATER. INSPECTIONS MUST BE DOCUMENTED AND BE IN FULL ACCORDANCE WITH THE MINIMUM CRITERIA SET FORTH BY ALL LOCAL & STATE STORM WATER RESOLUTIONS, TDEC AND THE CURRENT TENNESSEE GENERAL

APPROX. LOCATION FIRE HYDRANT TOTAL DISTURBED AREA = 37,676 SF $(0.86\pm$ AC) - CONCRETE WASHOUT SWPPP LEGEND

- TEMP. CONSTRUCTION ENTRANCE


- SILTATION FENCING STONE CHECK DAM

- OUTLET PROTECTION - INLET PROTECTION

- STONE FILTER RING GEOGRID MATTING

- STRAW WATTLE - GEOGRID MATTED DITCH

GEOGRID MATTING (SEE SHT C3.3 FOR DETAILS)

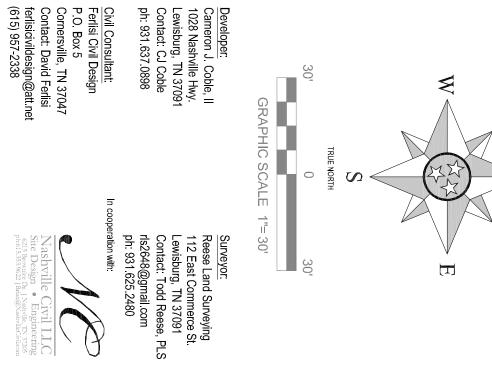

Permit-Seal:

P.O. Box 5 Cornersville, TN 37047

Cameron J. Coble, II
1028 Nashville Hwy.
Lewisburg, TN 37091
Contact: CJ Coble
ph: 931.637.0898

BARNER DENGLISH

Client/Project:

1028 Nashville Highway Lewisburg, TN 37097 Cameron J. Coble, II

The utility information shown hereon was taken from actual field evidence, utility agency records, or any other available evidence. Other utilites may exist and may not be shown, or may vary from where shown. No guarantee is expressed or implied in reguard to the utility locations shown hereon. The Owner(s) and Contractor(s) should assume responsibility to verify utility existence, size, location, depth, and availability of service, and be soley responsible for contacting the utility location service prior to commencing construction.

UTILITY

NOTES AND OWNERS

Multifamily Residential 915 Old Belfast Road 3rd Civil District Lewisburg, Marshall County, TN

Telephone AT&T 1-800-626-9149

Lewisburg Water & Waster 100 Water Street PO Box 2787 Lewisburg, TN 37091 931-359-6831

Electric
Lewisburg Electric Syster
599 W. Ellington Pkwy
Lewisburg, TN 37091
931-359-2544

Cable Charter Cable 1-855-872-0428

Lewisburg Water & Waste 100 Water Street PO Box 2787 Lewisburg, TN 37091 931-359-6831

Lewisburg Gas Company 505 N. Ellington Pkwy Lewisburg, TN 37091 931-359-4016

Public Works Lewisburg Public Works 927 5th Ave N Lewisburg, TN 37091 931-359-3563

Revisions:

Date:

By graphic plotting only, this property is in Zone(s) "X" of the Flood Insurance Rate Map Community Panel No. 47117C0040D which bears an effective date of September 28, 2007. No field surveying was performed to determine this zone and an elevation certificate may be needed to verify this determination or apply for a variance from the Federal Emergency Management Agency.

FLOOD NOTE

- LIMITS OF DISTURBANCE

SITE GRADING & DRAINAGE NOTES:

1. THE EXISTING CONDITIONS INDICATED ON THE PLANS WERE OBTAINED FROM A TOPOGRAPHIC MAP PROVIDED BY THE OWNER TO THE ENGINEER FOR USE IN HIS DESIGN. THE ENGINEER DOES NOT GUARANTEE OR IN ANY WAY WARRANTY THE ACCURACY OR COMPLETENESS OF THE INDICATED EXISTING TOPOGRAPHIC INFORMATION SHOWN HEREIN, INCLUDING THE EXISTENCE, LOCATION & DEPTH OF ALL EXISTING UTILITIES WITHIN AND AROUND THE LIMITS OF CONSTRUCTION. THE CONTRACTOR SHALL BE SOLELY RESPONSIBLE FOR FIELD VERIFYING THE PRESENCE, EXACT LOCATION & DEPTH OF ANY/ALL EXISTING UTILITIES PRIOR TO COMMENCING WITH CONSTRUCTION ACTIVITIES. CONTRACTOR TO CONTACT TENNESSEE ONE-CALL (800) 351-1111, (615) 366-1967 A MINIMUM OF 24 HRS PRIOR TO COMMENCING WITH CONSTRUCTION ACTIVITIES.

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Drawn By: Checked By: Designed By Project No DPF DPF DPF 8/24/22

Scale: AS NOTED

Title:

INTERIM & FINAL STORMWATER POLLUTION PREVENTION PLAN

5. THE CONTRACTOR SHALL INSTALL AND MAINTAIN SEDIMENTATION/EROSION CONTROL DEVICES AS INDICATED ON THE ACCOMPANYING STORM WATER POLLUTION PREVENTION PLAN (SWPPP). IF SWPPP IS NOT REQUIRED OR PROVIDED, THE CONTRACTOR SHALL PROVIDE ANY NECESSARY SEDIMENTATION/EROSION CONTROL DEVICES AS REQUIRED TO PREVENT ANY SEDIMENTATION FROM LEAVING THE LIMITS OF THE SITE. NO CONSTRUCTION ACTIVITIES SHALL COMMENCE UNTIL ADEQUATE SEDIMENTATION/EROSION CONTROL MEASURES ARE IN PLACE AND PROPERLY INSTALLED.

6. UPON COMPLETION OF THE REQUIRED WORK, THE CONTRACTOR SHALL DISTRIBUTE A MIN. 6" TOPSOIL TO PROPOSED GRASSED AND LANDSCAPE AREAS, FINE GRADE AND PROMPTLY STABILIZE ALL DISTURBED AREAS. THE CONTRACTOR SHALL REFER TO SITE LANDSCAPING PLANS AND SPECIFICATIONS (IF PROVIDED IN THESE PLANS) TO DETERMINE THE LOCATION AND TYPE OF PERMANENT GROUND COVER. AT A MINIMUM, SEED AND MULCH SHALL BE APPLIED TO ALL DISTURBED AREAS AS SOON AS FEASIBLE POSSIBLE.

TOTAL DISTURBED AREA IS < 1.0 ACRES,
 (NOI/NOC) IS NOT REQUIRED FOR THIS PROJECT.

THEREFORE

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