

VICINITY MAP

# 

TRACK WEST PARTNERS 445 BISHOP ST NW ATLANTA, GEORGIA PHONE: (404) 913-9131 matt@trackwestpartners.com

SITE ADDRESS: 1290 NORTH ELLINGTON PARKWAY LEWISBURG, TENNESSEE

CSD PROJECT NUMBER: TRW-2119

- GRADING & EROSION CONTROL PLAN
- UTILITY PLAN

- **DETAILS**
- EXTERIOR ELEVATION 1
- **EXTERIOR ELEVATION 2**

# SHEET INDEX

C-1	<b>EXISTING</b>	CONDITIONS.	/ DEMOLITION PLAN

C-2 SITE PLAN

LANDSCAPE PLAN

LIGHTING PLAN

**DETAILS** 

**DETAILS** 

DUMPSTER ENCLOSURE

**EQUIPMENT PLAN** 

PROPOSED MONUMENT SIGN



WWW.CSITEDESIGN.COM

RALEIGH, NORTH CAROLINA 27613

SITE INFORMATION

0570 A 047.06

TRACK WEST PARTNERS

8312 CREEDMOOR ROAD

FAX: (919) 848-3741

41 REGULAR SPACES 2 HANDICAP SPACES 43 TOTAL SPACES

40,354 SF OR 0.93 ACRES

45,262 SF OR 1.03 ACRES

1,973 SF OR 0.05 ACRES

30,627 SF OR 0.70 ACRES

20 FEET 0 FEET 20 FEET

45 BISHOP STREET NW ATLANTA, GA 20318 PHONE: (404) 913-9131

1290 NORTH ELLINGTON PARKWAY

COMMERCIAL SITE DESIGN, PLLC

RALEIGH, NORTH CAROLINA 27613

C-2 (INTERMEDIATE BUSINESS)

RESTAURANT WITH DRIVE-THROUGH

22 SPACES REQUIRED PER LEWISBURG

LEWISBURG WATER AND WASTEWATER

LEWISBURG WATER AND WASTEWATER

SITE ADDRESS:

DEVELOPER:

DESIGNER:

ZONING:

EXISTING USE:

PROPOSED USE:

FRONT.

**BUILDING SETBACKS:** 

PARKING PROVIDED:

TOTAL SITE AREA:

DISTURBED AREA:

BUILDING AREA:

WATER:


SEWER:

PARKING REQUIREMENTS:


EXISTING IMPERVIOUS AREA:

PROPOSED IMPERVIOUS AREA:

PARCEL IDENTIFICATION NUMBER:

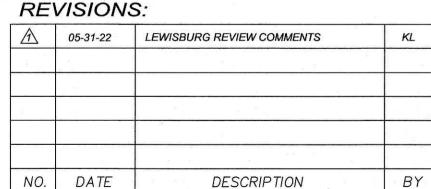



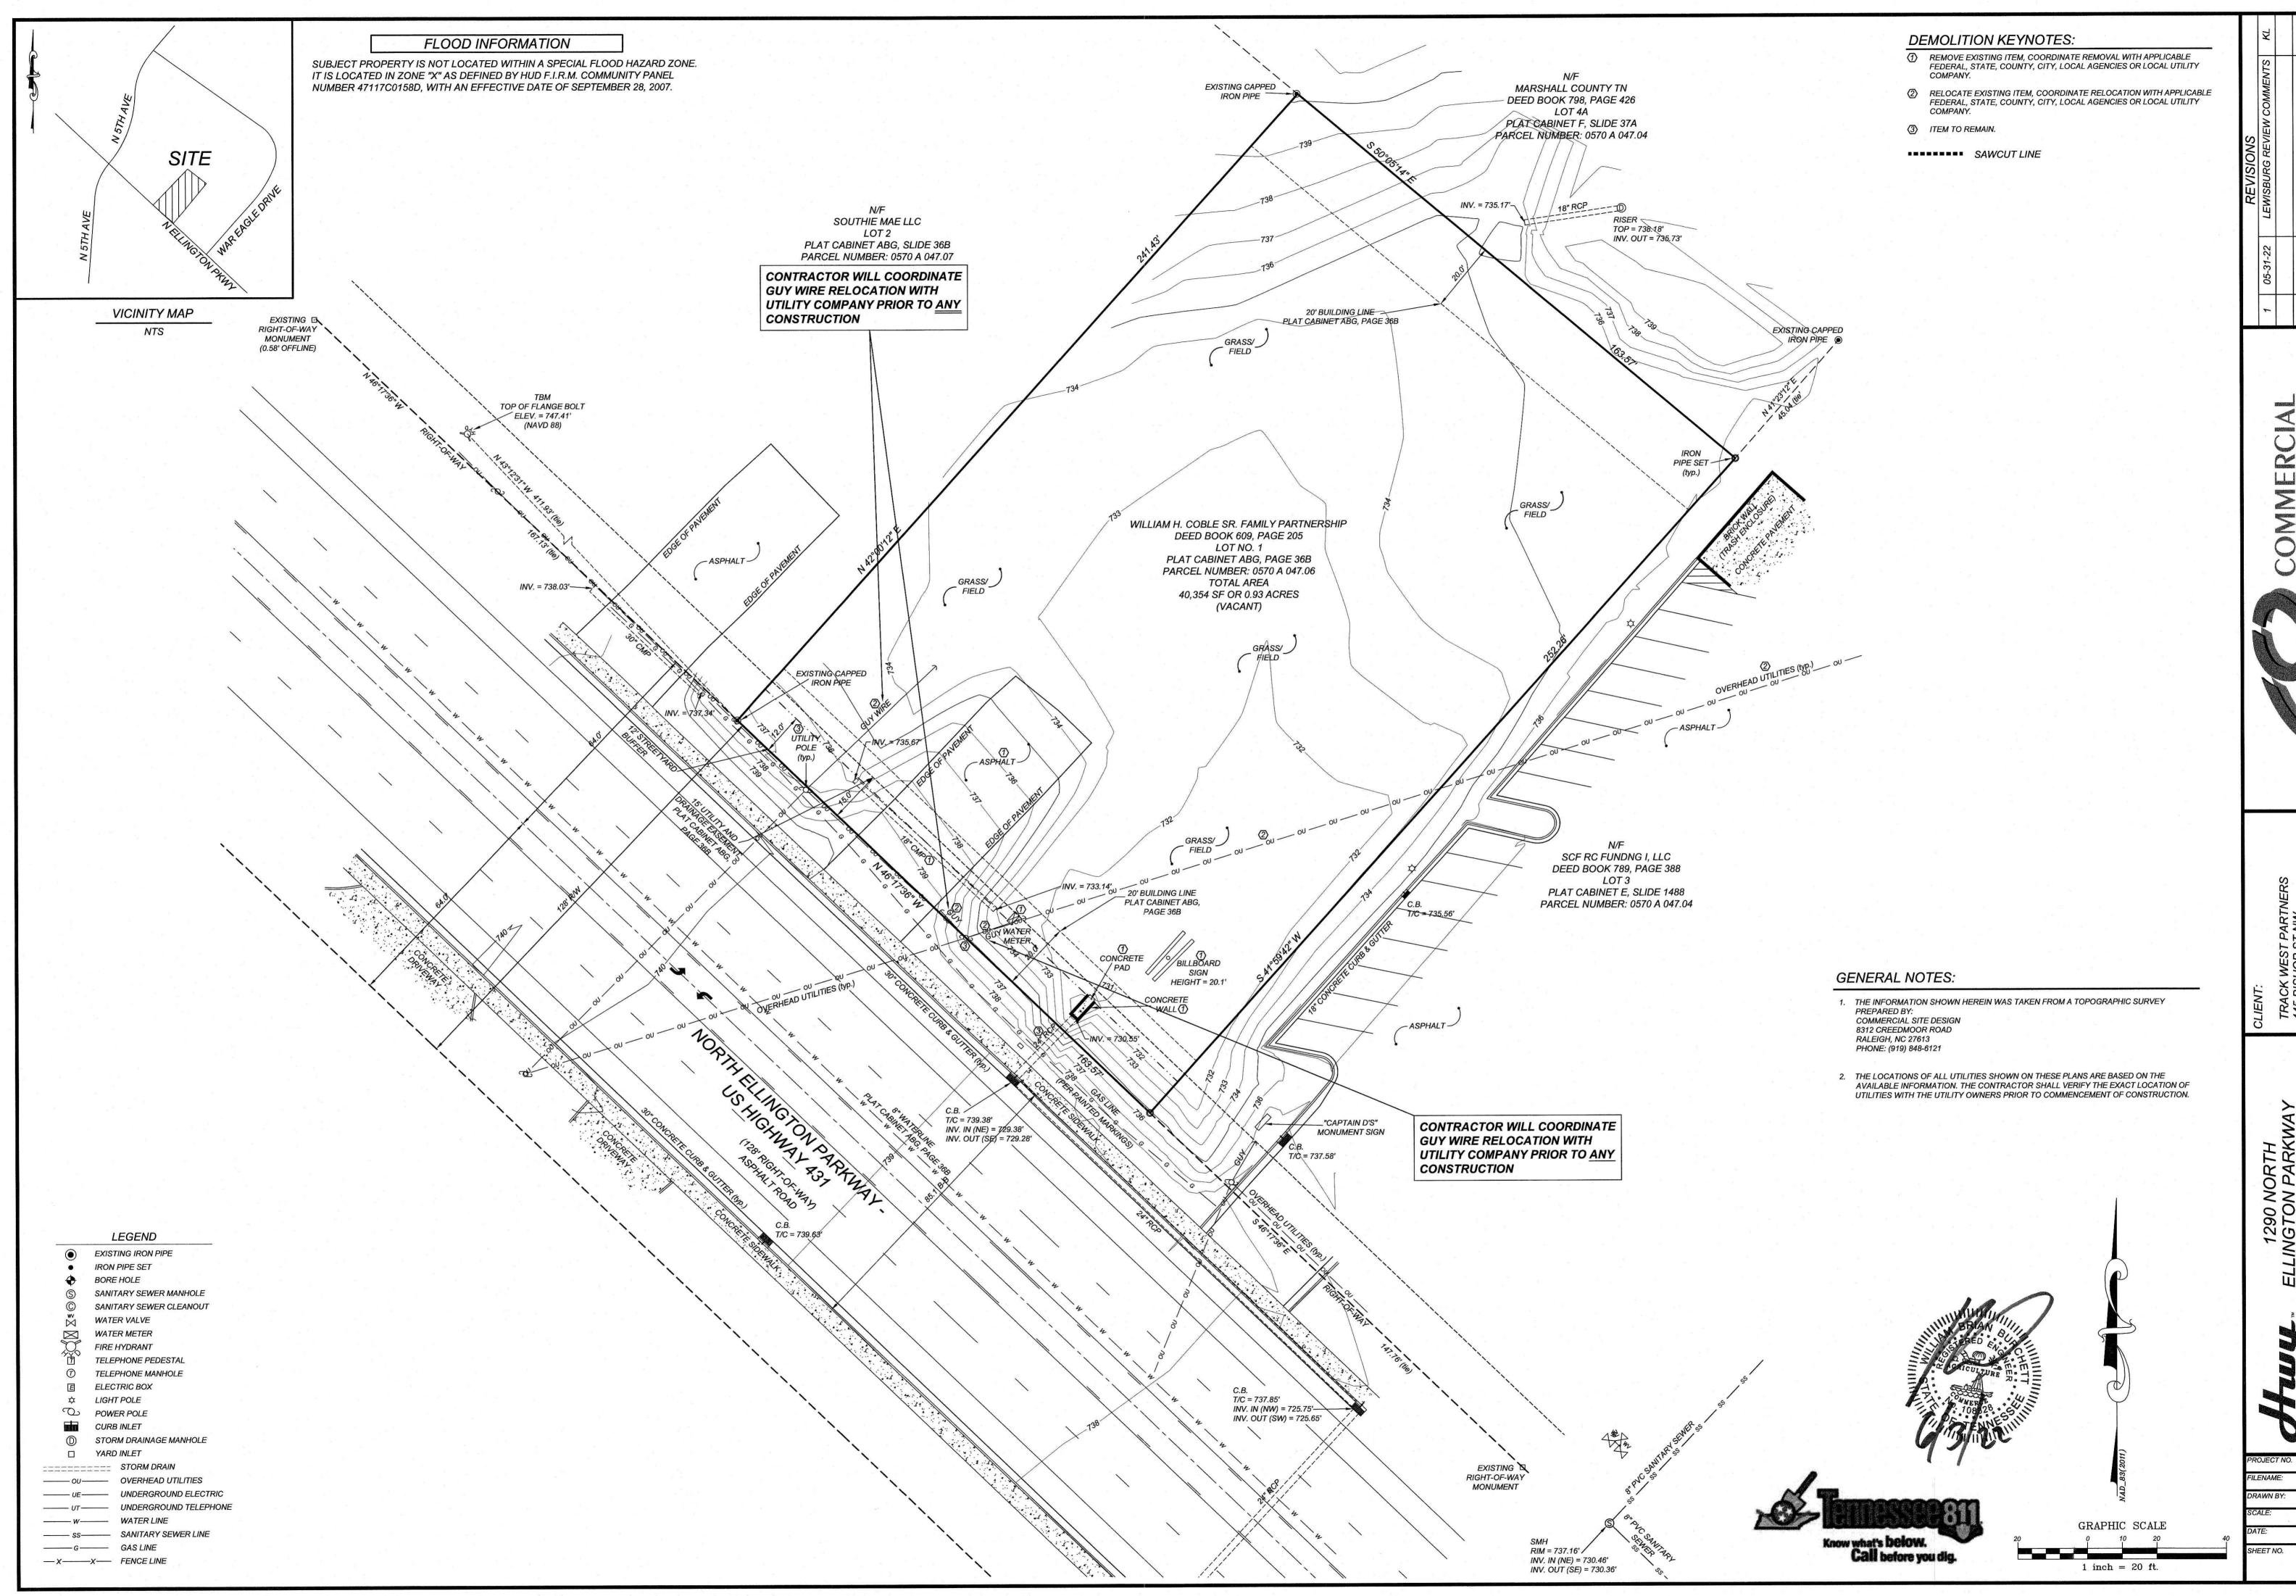

05-31-22 LEWISBURG REVIEW COMM
DATE DESCRIPTION

EDESIGN
(919) 848-6121, FAX: (919) 848-5741

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TRACK WEST PARTNERS 445 BISHOP ST NW 4TLANTA, GA 20318 PHONE: (404) 913-9131 Matt@Trackwestpartners.com

ON PARKWAY RG, TENNESSEE

STING CONDITION


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TRW2119-DP


RCN

1" = 20'

01-18-2022

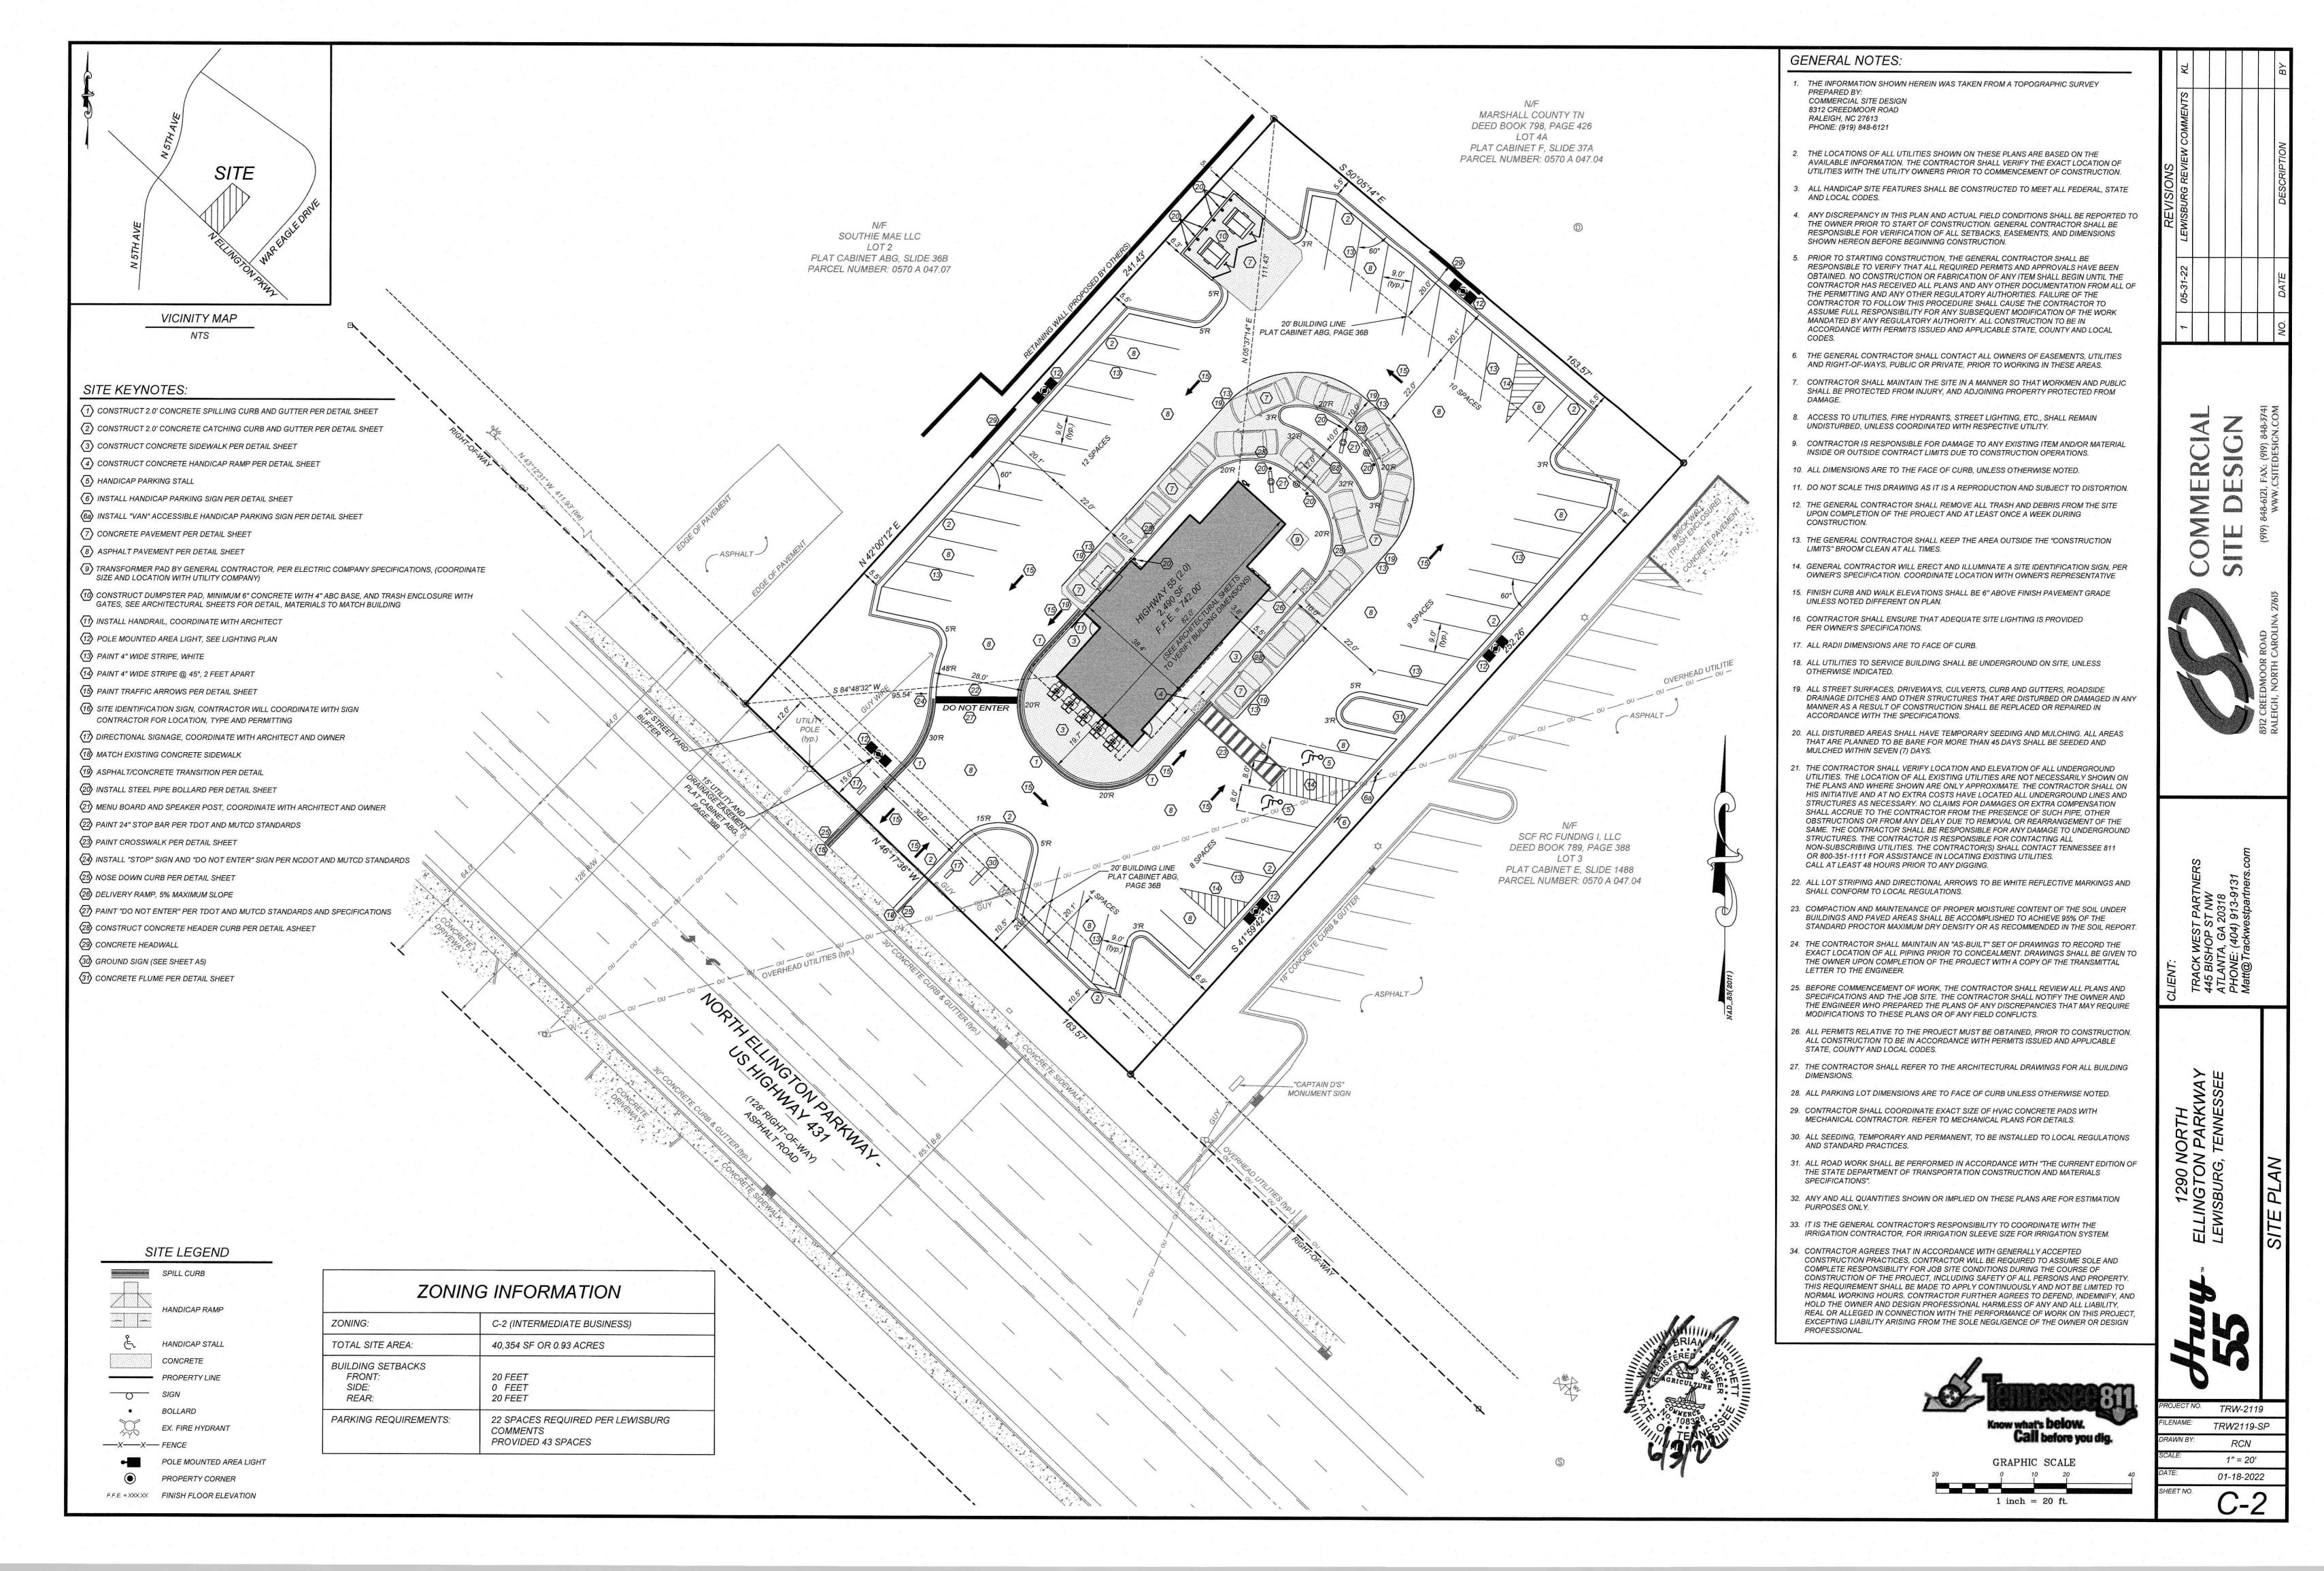

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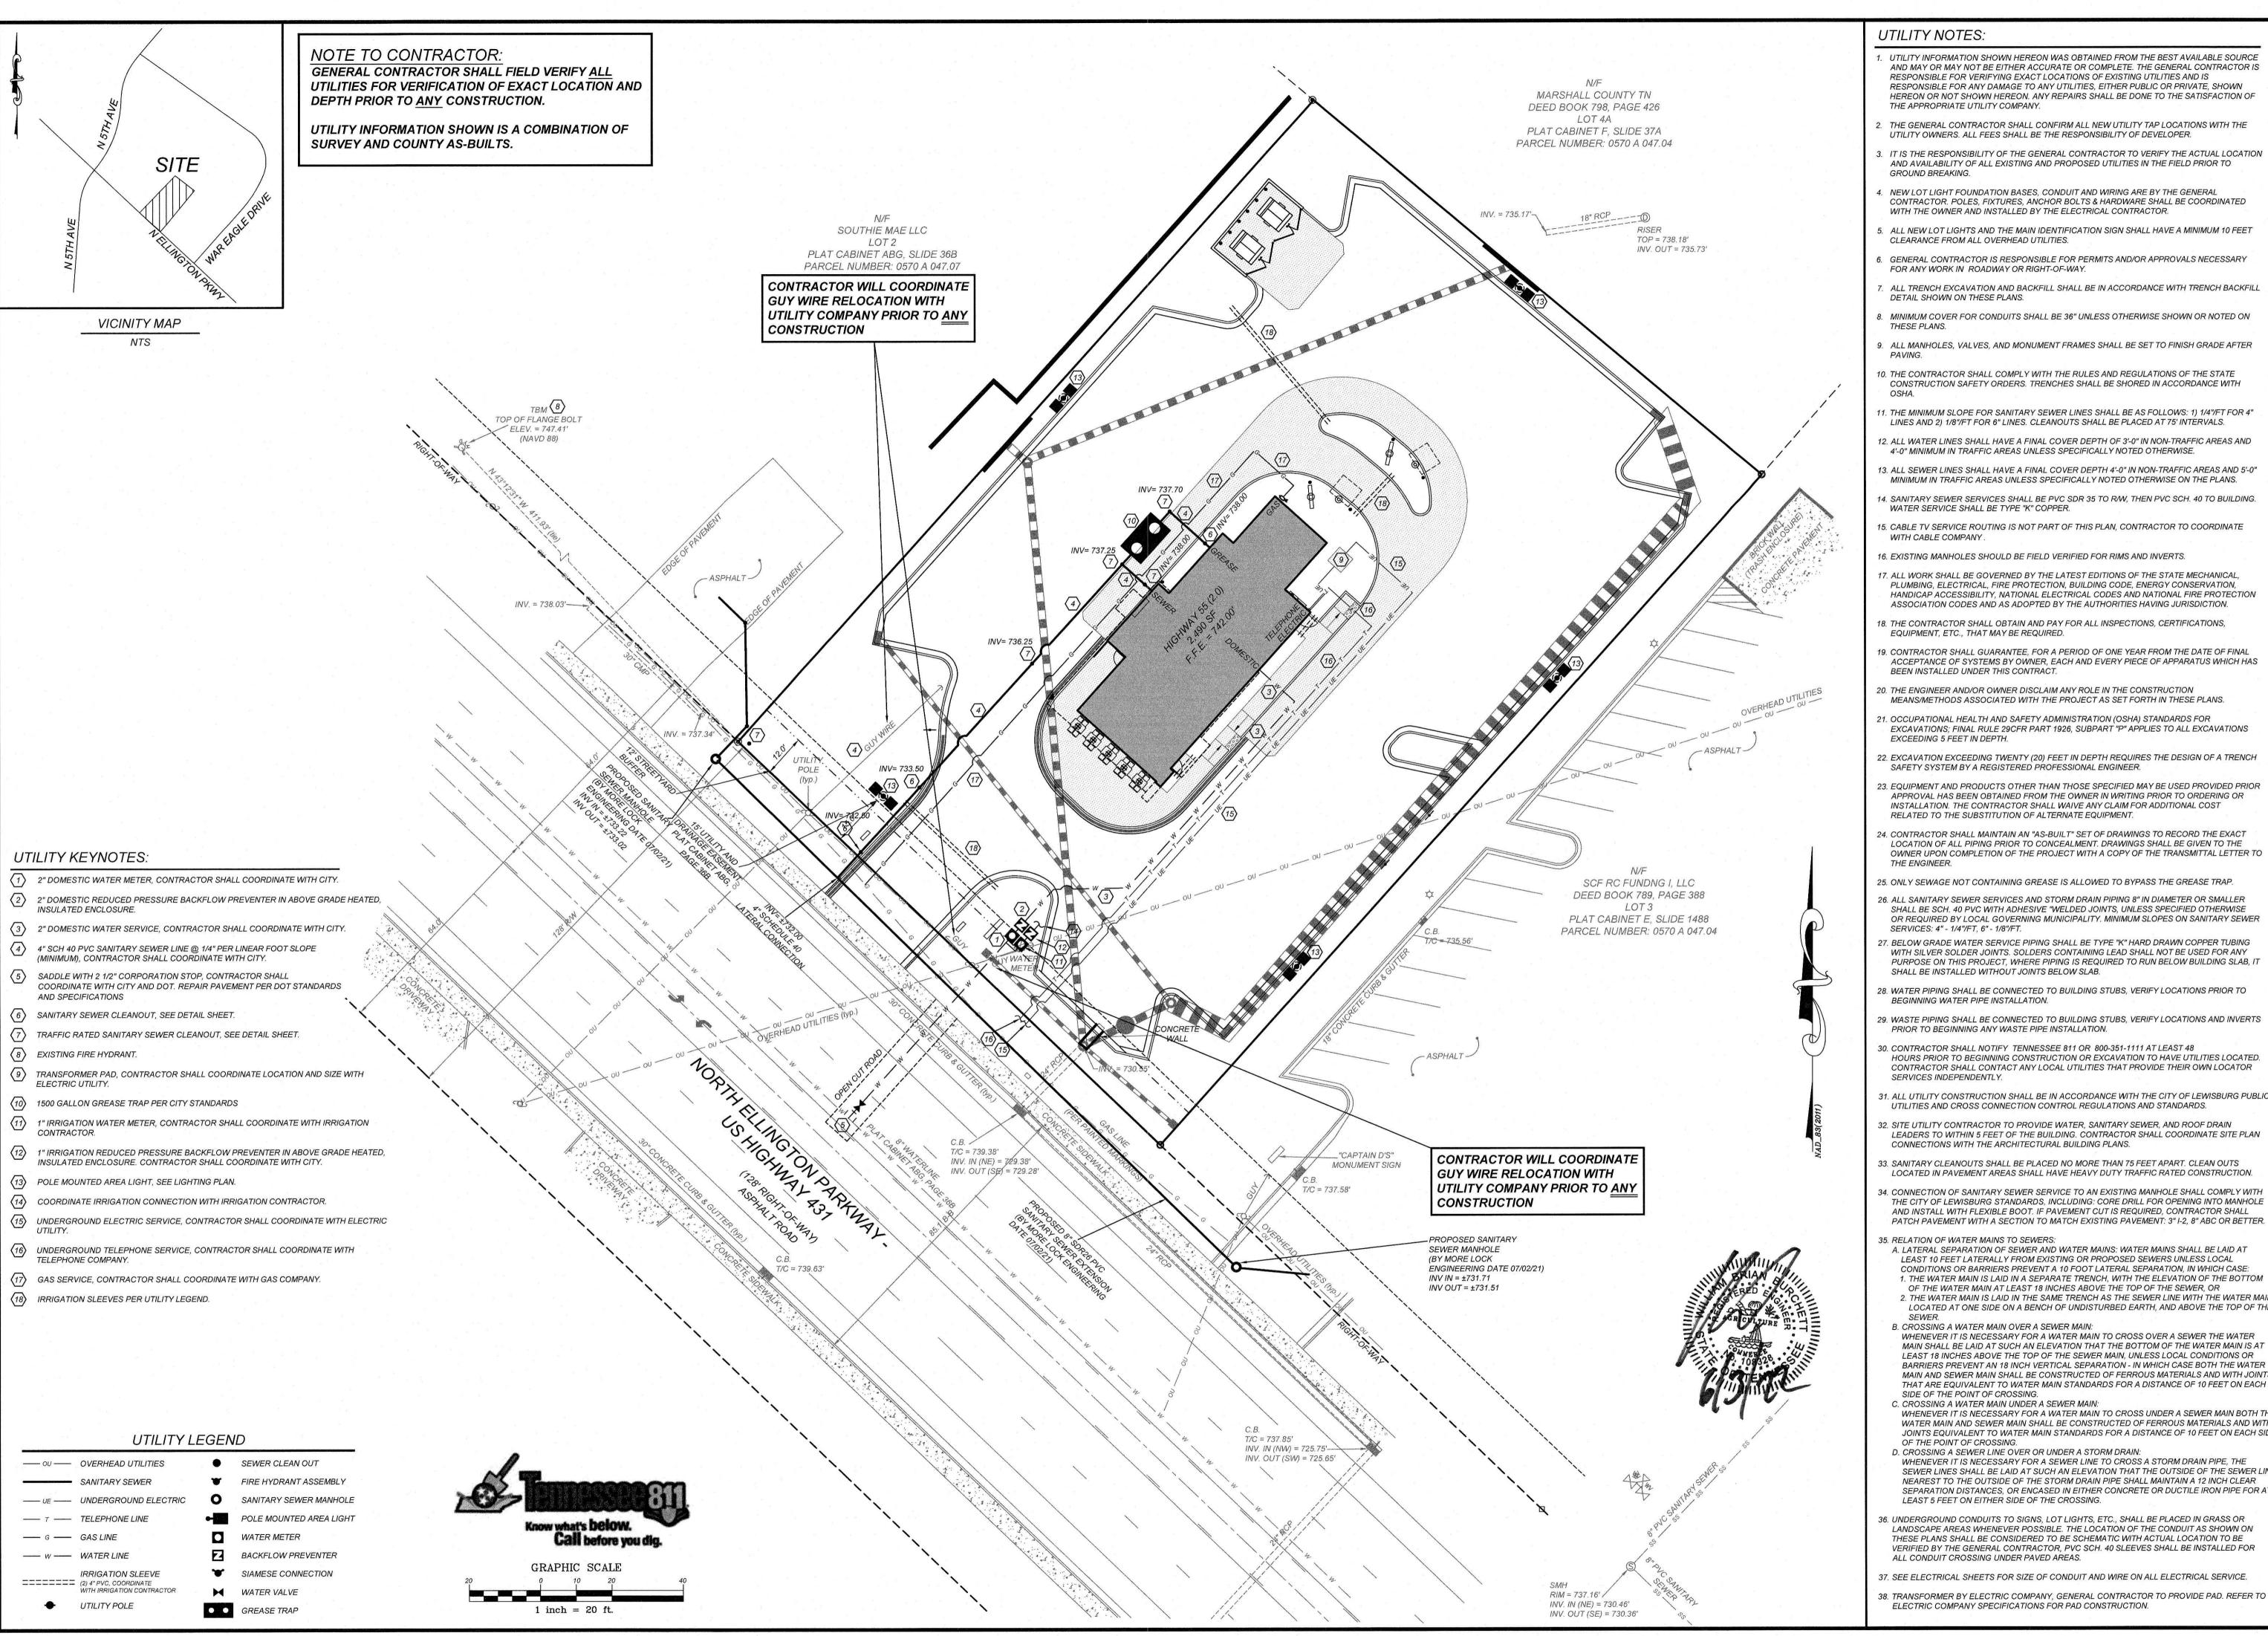


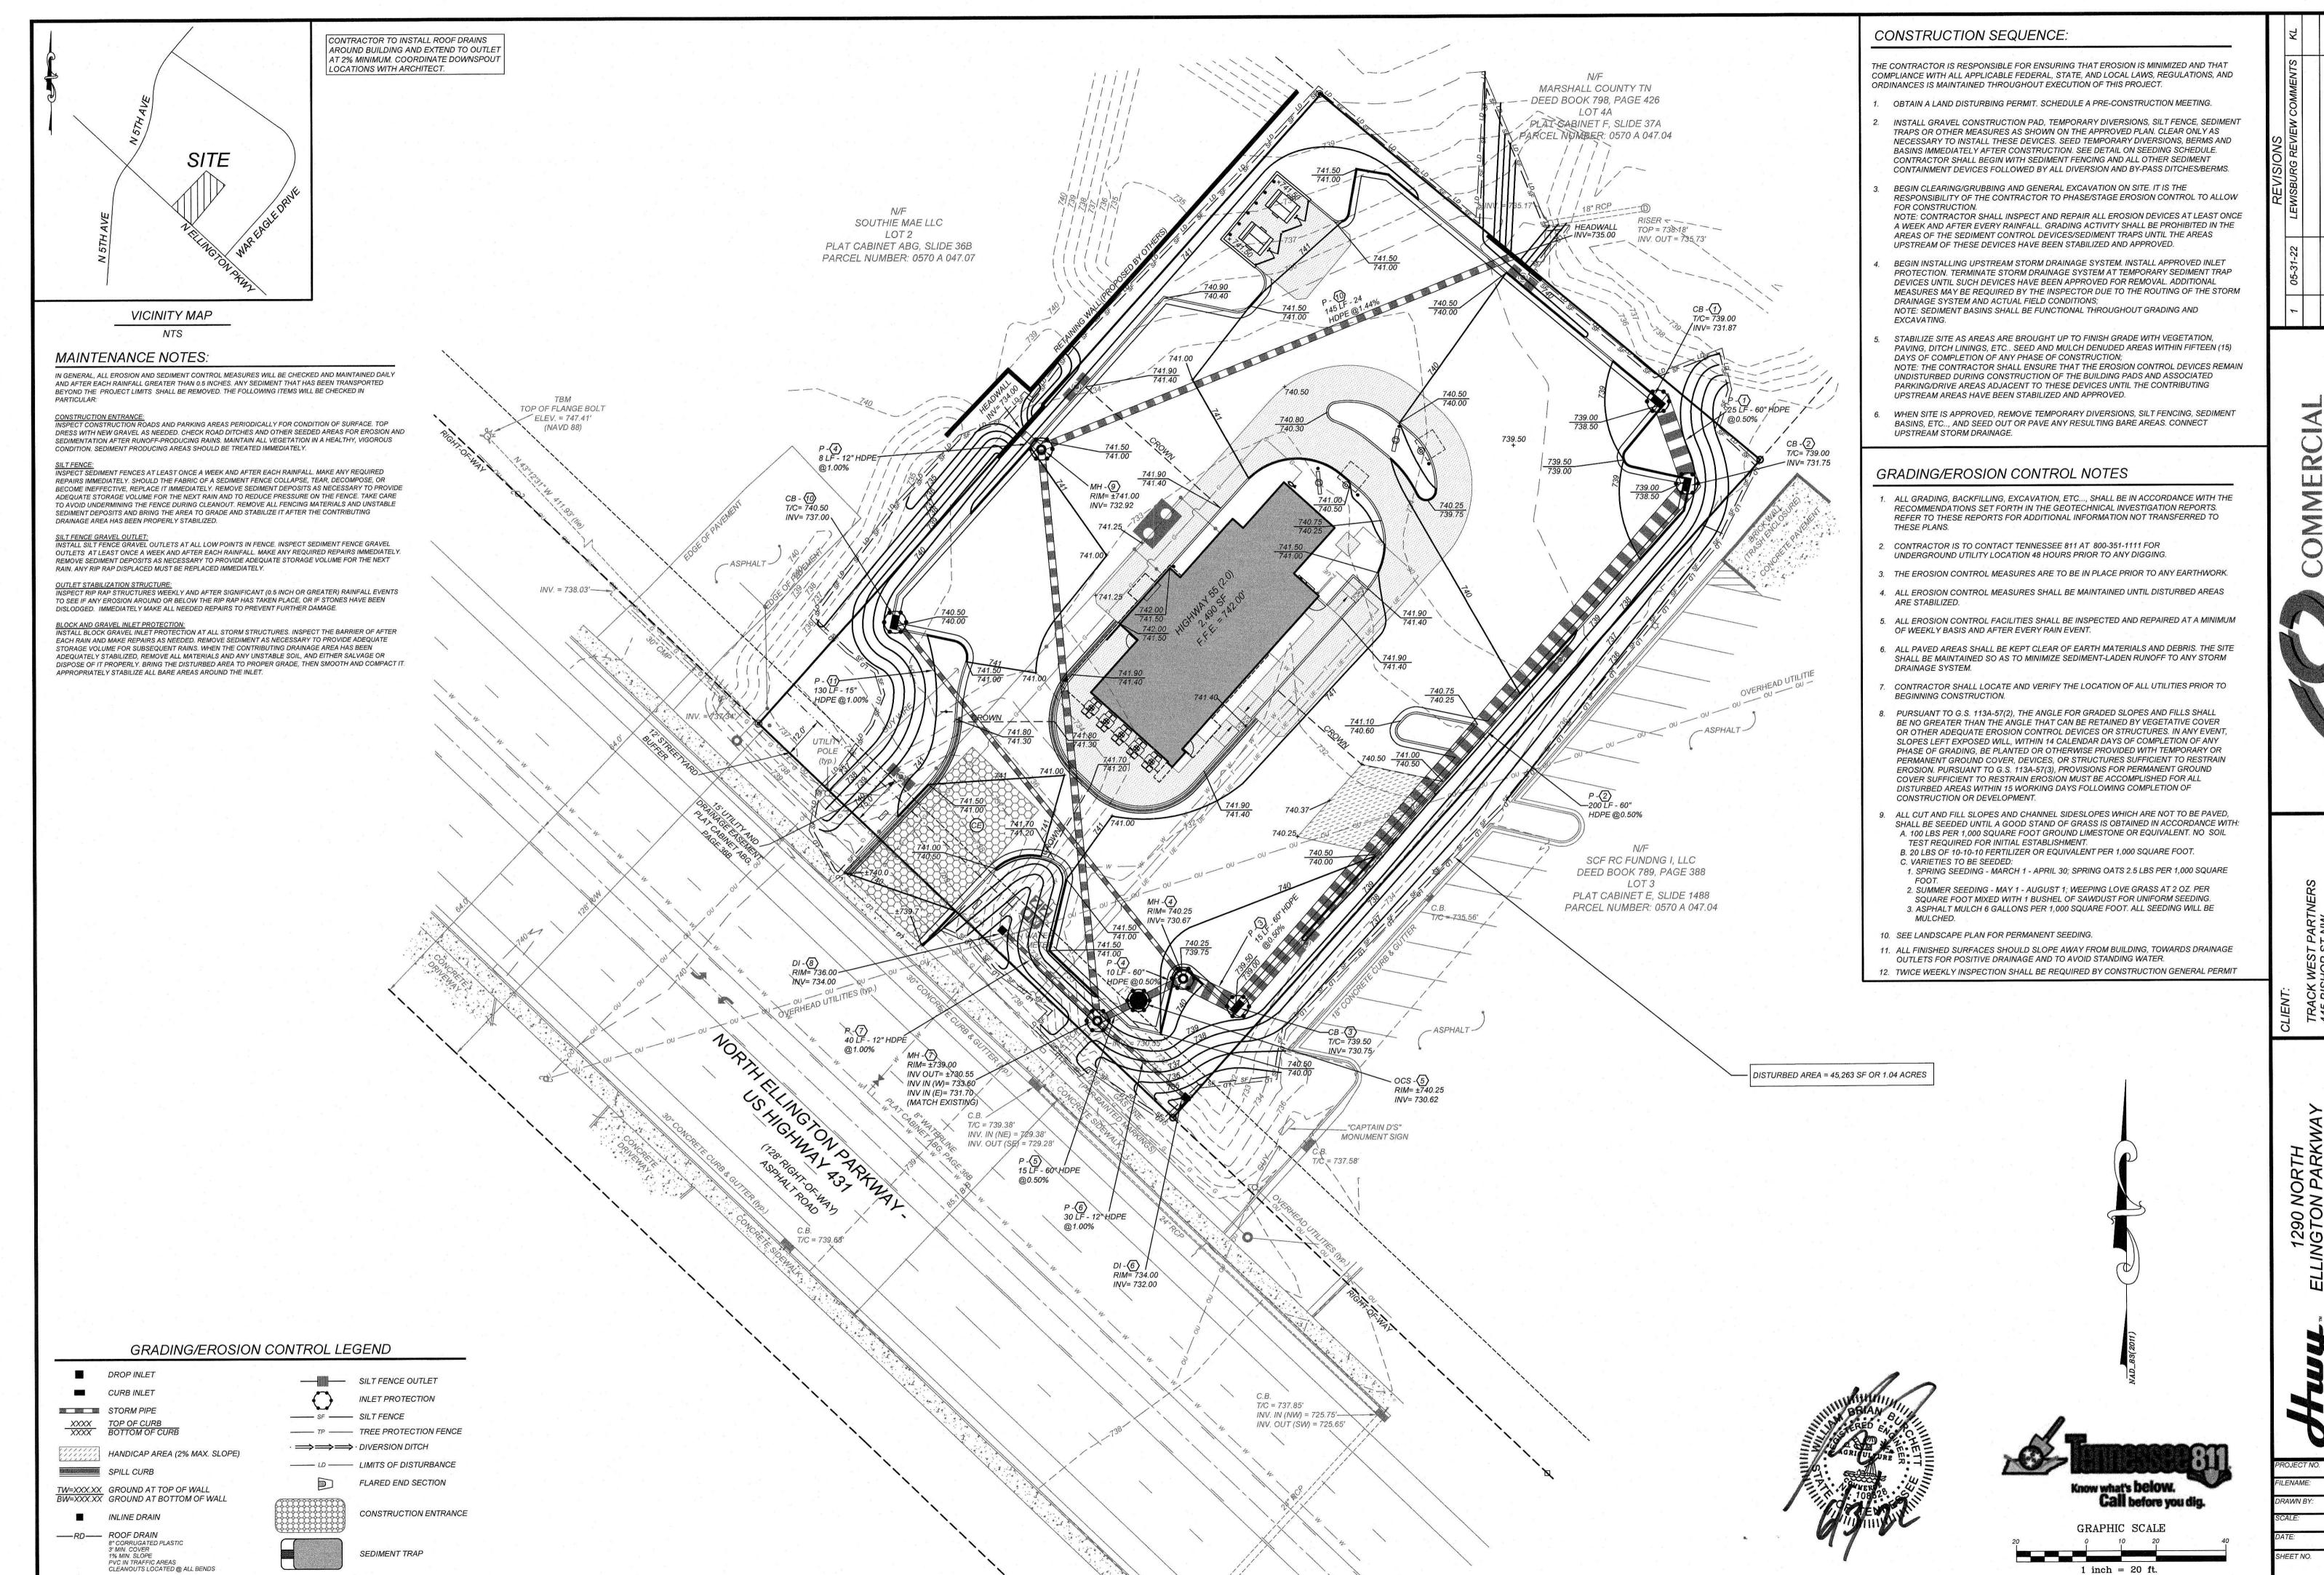TRW-2119 TRW2119-GP RCN 1'' = 20'

C-3

01-18-2022

1 inch = 20 ft.




- 1. UTILITY INFORMATION SHOWN HEREON WAS OBTAINED FROM THE BEST AVAILABLE SOURCE AND MAY OR MAY NOT BE EITHER ACCURATE OR COMPLETE. THE GENERAL CONTRACTOR IS RESPONSIBLE FOR VERIFYING EXACT LOCATIONS OF EXISTING UTILITIES AND IS RESPONSIBLE FOR ANY DAMAGE TO ANY UTILITIES, EITHER PUBLIC OR PRIVATE, SHOWN HEREON OR NOT SHOWN HEREON. ANY REPAIRS SHALL BE DONE TO THE SATISFACTION OF THE APPROPRIATE UTILITY COMPANY.
- THE GENERAL CONTRACTOR SHALL CONFIRM ALL NEW UTILITY TAP LOCATIONS WITH THE UTILITY OWNERS. ALL FEES SHALL BE THE RESPONSIBILITY OF DEVELOPER.
- 3. IT IS THE RESPONSIBILITY OF THE GENERAL CONTRACTOR TO VERIFY THE ACTUAL LOCATION AND AVAILABILITY OF ALL EXISTING AND PROPOSED UTILITIES IN THE FIELD PRIOR TO
- NEW LOT LIGHT FOUNDATION BASES, CONDUIT AND WIRING ARE BY THE GENERAL CONTRACTOR. POLES, FIXTURES, ANCHOR BOLTS & HARDWARE SHALL BE COORDINATED
- ALL NEW LOT LIGHTS AND THE MAIN IDENTIFICATION SIGN SHALL HAVE A MINIMUM 10 FEET
- GENERAL CONTRACTOR IS RESPONSIBLE FOR PERMITS AND/OR APPROVALS NECESSARY
- FOR ANY WORK IN ROADWAY OR RIGHT-OF-WAY. ALL TRENCH EXCAVATION AND BACKFILL SHALL BE IN ACCORDANCE WITH TRENCH BACKFILL

- ALL MANHOLES, VALVES, AND MONUMENT FRAMES SHALL BE SET TO FINISH GRADE AFTER
- 10. THE CONTRACTOR SHALL COMPLY WITH THE RULES AND REGULATIONS OF THE STATE CONSTRUCTION SAFETY ORDERS. TRENCHES SHALL BE SHORED IN ACCORDANCE WITH
- 1. THE MINIMUM SLOPE FOR SANITARY SEWER LINES SHALL BE AS FOLLOWS: 1) 1/4"/FT FOR 4" LINES AND 2) 1/8"/FT FOR 6" LINES, CLEANOUTS SHALL BE PLACED AT 75' INTÉRVALS.
- 12. ALL WATER LINES SHALL HAVE A FINAL COVER DEPTH OF 3'-0" IN NON-TRAFFIC AREAS AND
- 4'-0" MINIMUM IN TRAFFIC AREAS UNLESS SPECIFICALLY NOTED OTHERWISE. 13. ALL SEWER LINES SHALL HAVE A FINAL COVER DEPTH 4'-0" IN NON-TRAFFIC AREAS AND 5'-0"
- MINIMUM IN TRAFFIC AREAS UNLESS SPECIFICALLY NOTED OTHERWISE ON THE PLANS.
- 15. CABLE TV SERVICE ROUTING IS NOT PART OF THIS PLAN, CONTRACTOR TO COORDINATE
- 16. EXISTING MANHOLES SHOULD BE FIELD VERIFIED FOR RIMS AND INVERTS.
- 17. ALL WORK SHALL BE GOVERNED BY THE LATEST EDITIONS OF THE STATE MECHANICAL, PLUMBING, ELECTRICAL, FIRE PROTECTION, BUILDING CODE, ENERGY CONSERVATION, HANDICAP ACCESSIBILITY, NATIONAL ELECTRICAL CODES AND NATIONAL FIRE PROTECTION ASSOCIATION CODES AND AS ADOPTED BY THE AUTHORITIES HAVING JURISDICTION.
- 18. THE CONTRACTOR SHALL OBTAIN AND PAY FOR ALL INSPECTIONS, CERTIFICATIONS,
- 19. CONTRACTOR SHALL GUARANTEE, FOR A PERIOD OF ONE YEAR FROM THE DATE OF FINAL ACCEPTANCE OF SYSTEMS BY OWNER, EACH AND EVERY PIECE OF APPARATUS WHICH HAS
- D. THE ENGINEER AND/OR OWNER DISCLAIM ANY ROLE IN THE CONSTRUCTION
- 1. OCCUPATIONAL HEALTH AND SAFETY ADMINISTRATION (OSHA) STANDARDS FOR EXCAVATIONS; FINAL RULE 29CFR PART 1926, SUBPART "P" APPLIES TO ALL EXCAVATIONS
- 22. EXCAVATION EXCEEDING TWENTY (20) FEET IN DEPTH REQUIRES THE DESIGN OF A TRENCH SAFETY SYSTEM BY A REGISTERED PROFESSIONAL ENGINEER.
- 23. EQUIPMENT AND PRODUCTS OTHER THAN THOSE SPECIFIED MAY BE USED PROVIDED PRIOR APPROVAL HAS BEEN OBTAINED FROM THE OWNER IN WRITING PRIOR TO ORDERING OR INSTALLATION. THE CONTRACTOR SHALL WAIVE ANY CLAIM FOR ADDITIONAL COST
- 24. CONTRACTOR SHALL MAINTAIN AN "AS-BUILT" SET OF DRAWINGS TO RECORD THE EXACT LOCATION OF ALL PIPING PRIOR TO CONCEALMENT. DRAWINGS SHALL BE GIVEN TO THE OWNER UPON COMPLETION OF THE PROJECT WITH A COPY OF THE TRANSMITTAL LETTER TO
- 25. ONLY SEWAGE NOT CONTAINING GREASE IS ALLOWED TO BYPASS THE GREASE TRAP.
- 26. ALL SANITARY SEWER SERVICES AND STORM DRAIN PIPING 8" IN DIAMETER OR SMALLER SHALL BE SCH. 40 PVC WITH ADHESIVE "WELDED JOINTS, UNLESS SPECIFIED OTHERWISE OR REQUIRED BY LOCAL GOVERNING MUNICIPALITY. MINIMUM SLOPES ON SANITARY SEWER
- 27. BELOW GRADE WATER SERVICE PIPING SHALL BE TYPE "K" HARD DRAWN COPPER TUBING WITH SILVER SOLDER JOINTS. SOLDERS CONTAINING LEAD SHALL NOT BE USED FOR ANY PURPOSE ON THIS PROJECT, WHERE PIPING IS REQUIRED TO RUN BELOW BUILDING SLAB, IT SHALL BE INSTALLED WITHOUT JOINTS BELOW SLAB.
- 28. WATER PIPING SHALL BE CONNECTED TO BUILDING STUBS, VERIFY LOCATIONS PRIOR TO BEGINNING WATER PIPE INSTALLATION.
- 29. WASTE PIPING SHALL BE CONNECTED TO BUILDING STUBS, VERIFY LOCATIONS AND INVERTS PRIOR TO BEGINNING ANY WASTE PIPE INSTALLATION.
- 30. CONTRACTOR SHALL NOTIFY TENNESSEE 811 OR 800-351-1111 AT LEAST 48 HOURS PRIOR TO BEGINNING CONSTRUCTION OR EXCAVATION TO HAVE UTILITIES LOCATED. CONTRACTOR SHALL CONTACT ANY LOCAL UTILITIES THAT PROVIDE THEIR OWN LOCATOR
- 31. ALL UTILITY CONSTRUCTION SHALL BE IN ACCORDANCE WITH THE CITY OF LEWISBURG PUBLIC UTILITIES AND CROSS CONNECTION CONTROL REGULATIONS AND STANDARDS.
- 32. SITE UTILITY CONTRACTOR TO PROVIDE WATER, SANITARY SEWER, AND ROOF DRAIN LEADERS TO WITHIN 5 FEET OF THE BUILDING. CONTRACTOR SHALL COORDINATE SITE PLAN
- CONNECTIONS WITH THE ARCHITECTURAL BUILDING PLANS.
- 34. CONNECTION OF SANITARY SEWER SERVICE TO AN EXISTING MANHOLE SHALL COMPLY WITH THE CITY OF LEWISBURG STANDARDS, INCLUDING: CORE DRILL FOR OPENING INTO MANHOLE AND INSTALL WITH FLEXIBLE BOOT. IF PAVEMENT CUT IS REQUIRED, CONTRACTOR SHALL
- 35. RELATION OF WATER MAINS TO SEWERS: A. LATERAL SEPARATION OF SEWER AND WATER MAINS: WATER MAINS SHALL BE LAID AT LEAST 10 FEET LATERALLY FROM EXISTING OR PROPOSED SEWERS UNLESS LOCAL CONDITIONS OR BARRIERS PREVENT A 10 FOOT LATERAL SEPARATION, IN WHICH CASE:
- OF THE WATER MAIN AT LEAST 18 INCHES ABOVE THE TOP OF THE SEWER, OR 2. THE WATER MAIN IS LAID IN THE SAME TRENCH AS THE SEWER LINE WITH THE WATER MAIN LOCATED AT ONE SIDE ON A BENCH OF UNDISTURBED EARTH, AND ABOVE THE TOP OF THE
- B. CROSSING A WATER MAIN OVER A SEWER MAIN:
- WHENEVER IT IS NECESSARY FOR A WATER MAIN TO CROSS OVER A SEWER THE WATER MAIN SHALL BE LAID AT SUCH AN ELEVATION THAT THE BOTTOM OF THE WATER MAIN IS AT LEAST 18 INCHES ABOVE THE TOP OF THE SEWER MAIN. UNLESS LOCAL CONDITIONS OR BARRIERS PREVENT AN 18 INCH VERTICAL SEPARATION - IN WHICH CASE BOTH THE WATER MAIN AND SEWER MAIN SHALL BE CONSTRUCTED OF FERROUS MATERIALS AND WITH JOINTS THAT ARE EQUIVALENT TO WATER MAIN STANDARDS FOR A DISTANCE OF 10 FEET ON EACH SIDE OF THE POINT OF CROSSING.
- WHENEVER IT IS NECESSARY FOR A WATER MAIN TO CROSS UNDER A SEWER MAIN BOTH TH WATER MAIN AND SEWER MAIN SHALL BE CONSTRUCTED OF FERROUS MATERIALS AND WITH JOINTS EQUIVALENT TO WATER MAIN STANDARDS FOR A DISTANCE OF 10 FEET ON EACH SIDE
- WHENEVER IT IS NECESSARY FOR A SEWER LINE TO CROSS A STORM DRAIN PIPE, THE SEWER LINES SHALL BE LAID AT SUCH AN ELEVATION THAT THE OUTSIDE OF THE SEWER LINE NEAREST TO THE OUTSIDE OF THE STORM DRAIN PIPE SHALL MAINTAIN A 12 INCH CLEAR SEPARATION DISTANCES, OR ENCASED IN EITHER CONCRETE OR DUCTILE IRON PIPE FOR AT LEAST 5 FEET ON EITHER SIDE OF THE CROSSING.
- 6. UNDERGROUND CONDUITS TO SIGNS, LOT LIGHTS, ETC., SHALL BE PLACED IN GRASS OR LANDSCAPE AREAS WHENEVER POSSIBLE. THE LOCATION OF THE CONDUIT AS SHOWN ON THESE PLANS SHALL BE CONSIDERED TO BE SCHEMATIC WITH ACTUAL LOCATION TO BE VERIFIED BY THE GENERAL CONTRACTOR, PVC SCH. 40 SLEEVES SHALL BE INSTALLED FOR ALL CONDUIT CROSSING UNDER PAVED AREAS.
- 37. SEE ELECTRICAL SHEETS FOR SIZE OF CONDUIT AND WIRE ON ALL ELECTRICAL SERVICE.
- 38. TRANSFORMER BY ELECTRIC COMPANY, GENERAL CONTRACTOR TO PROVIDE PAD. REFER TO


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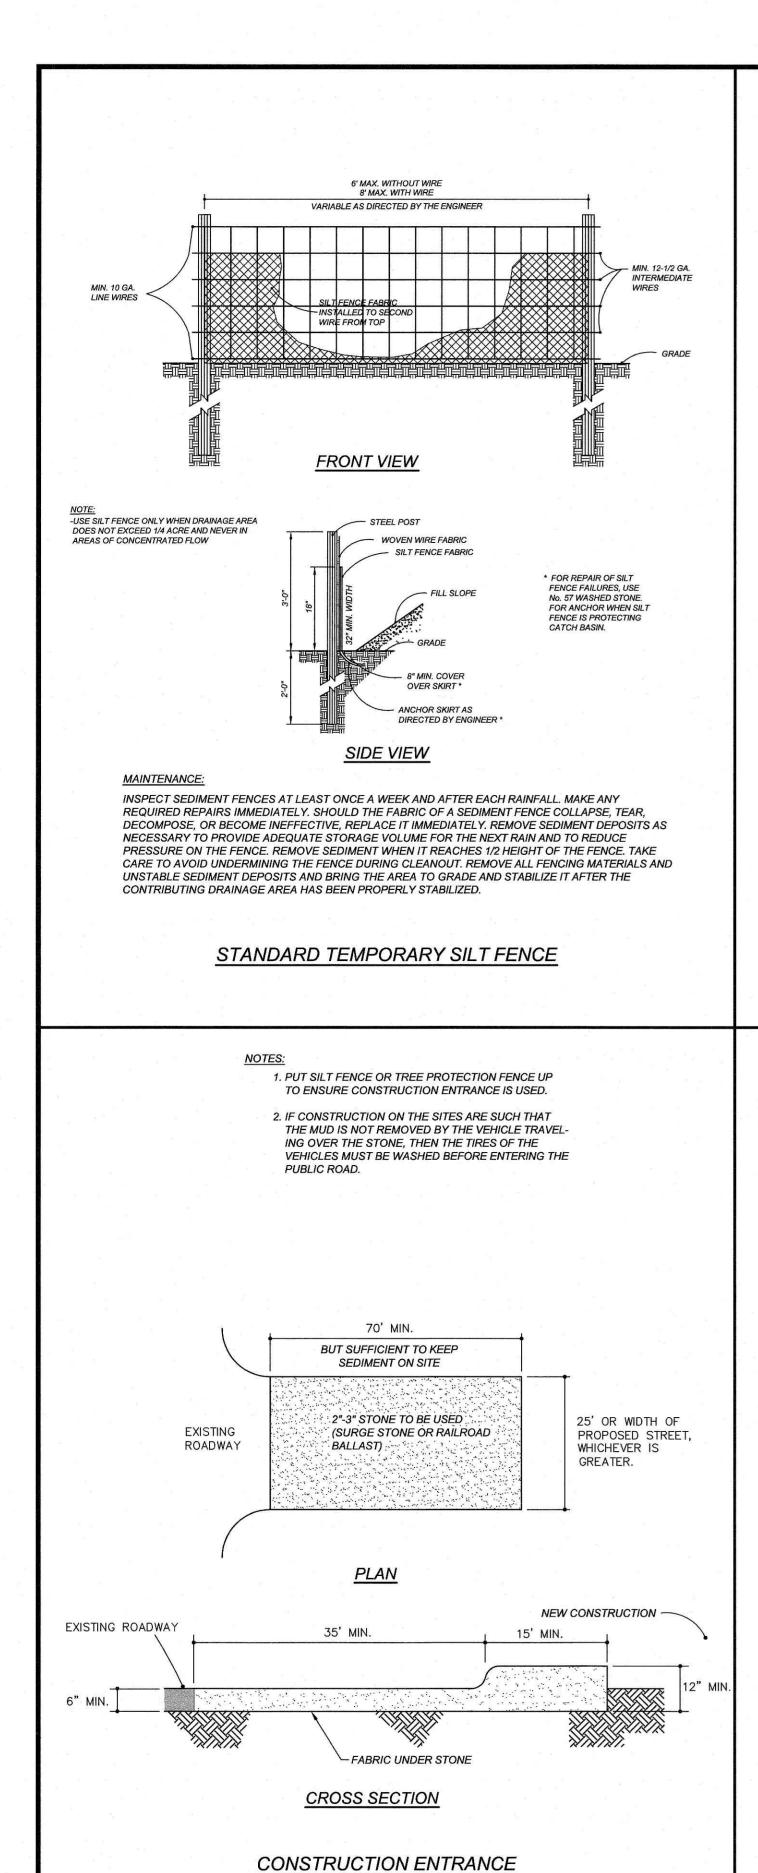
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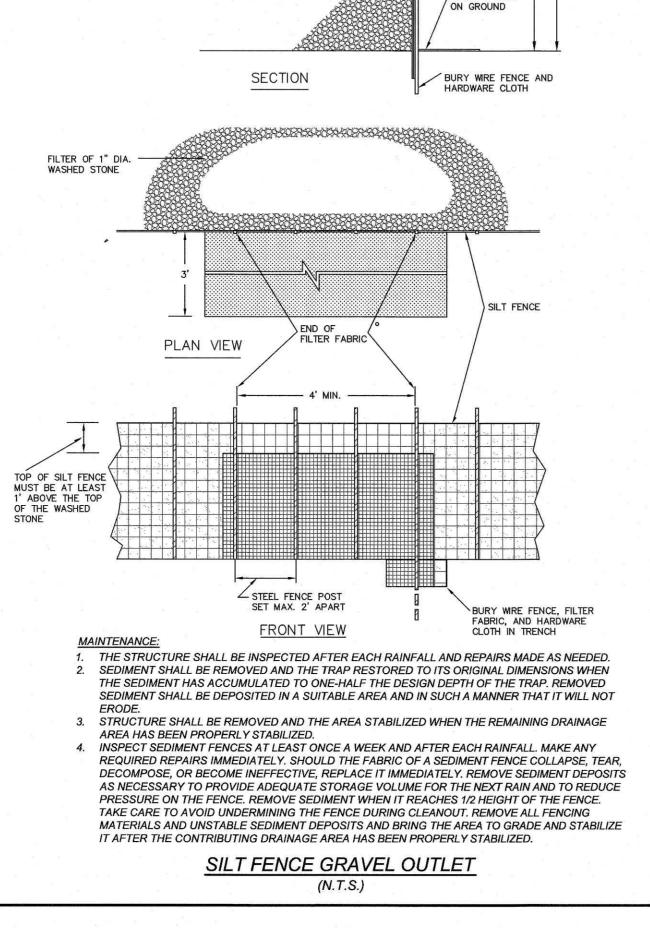


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- DEWATERING

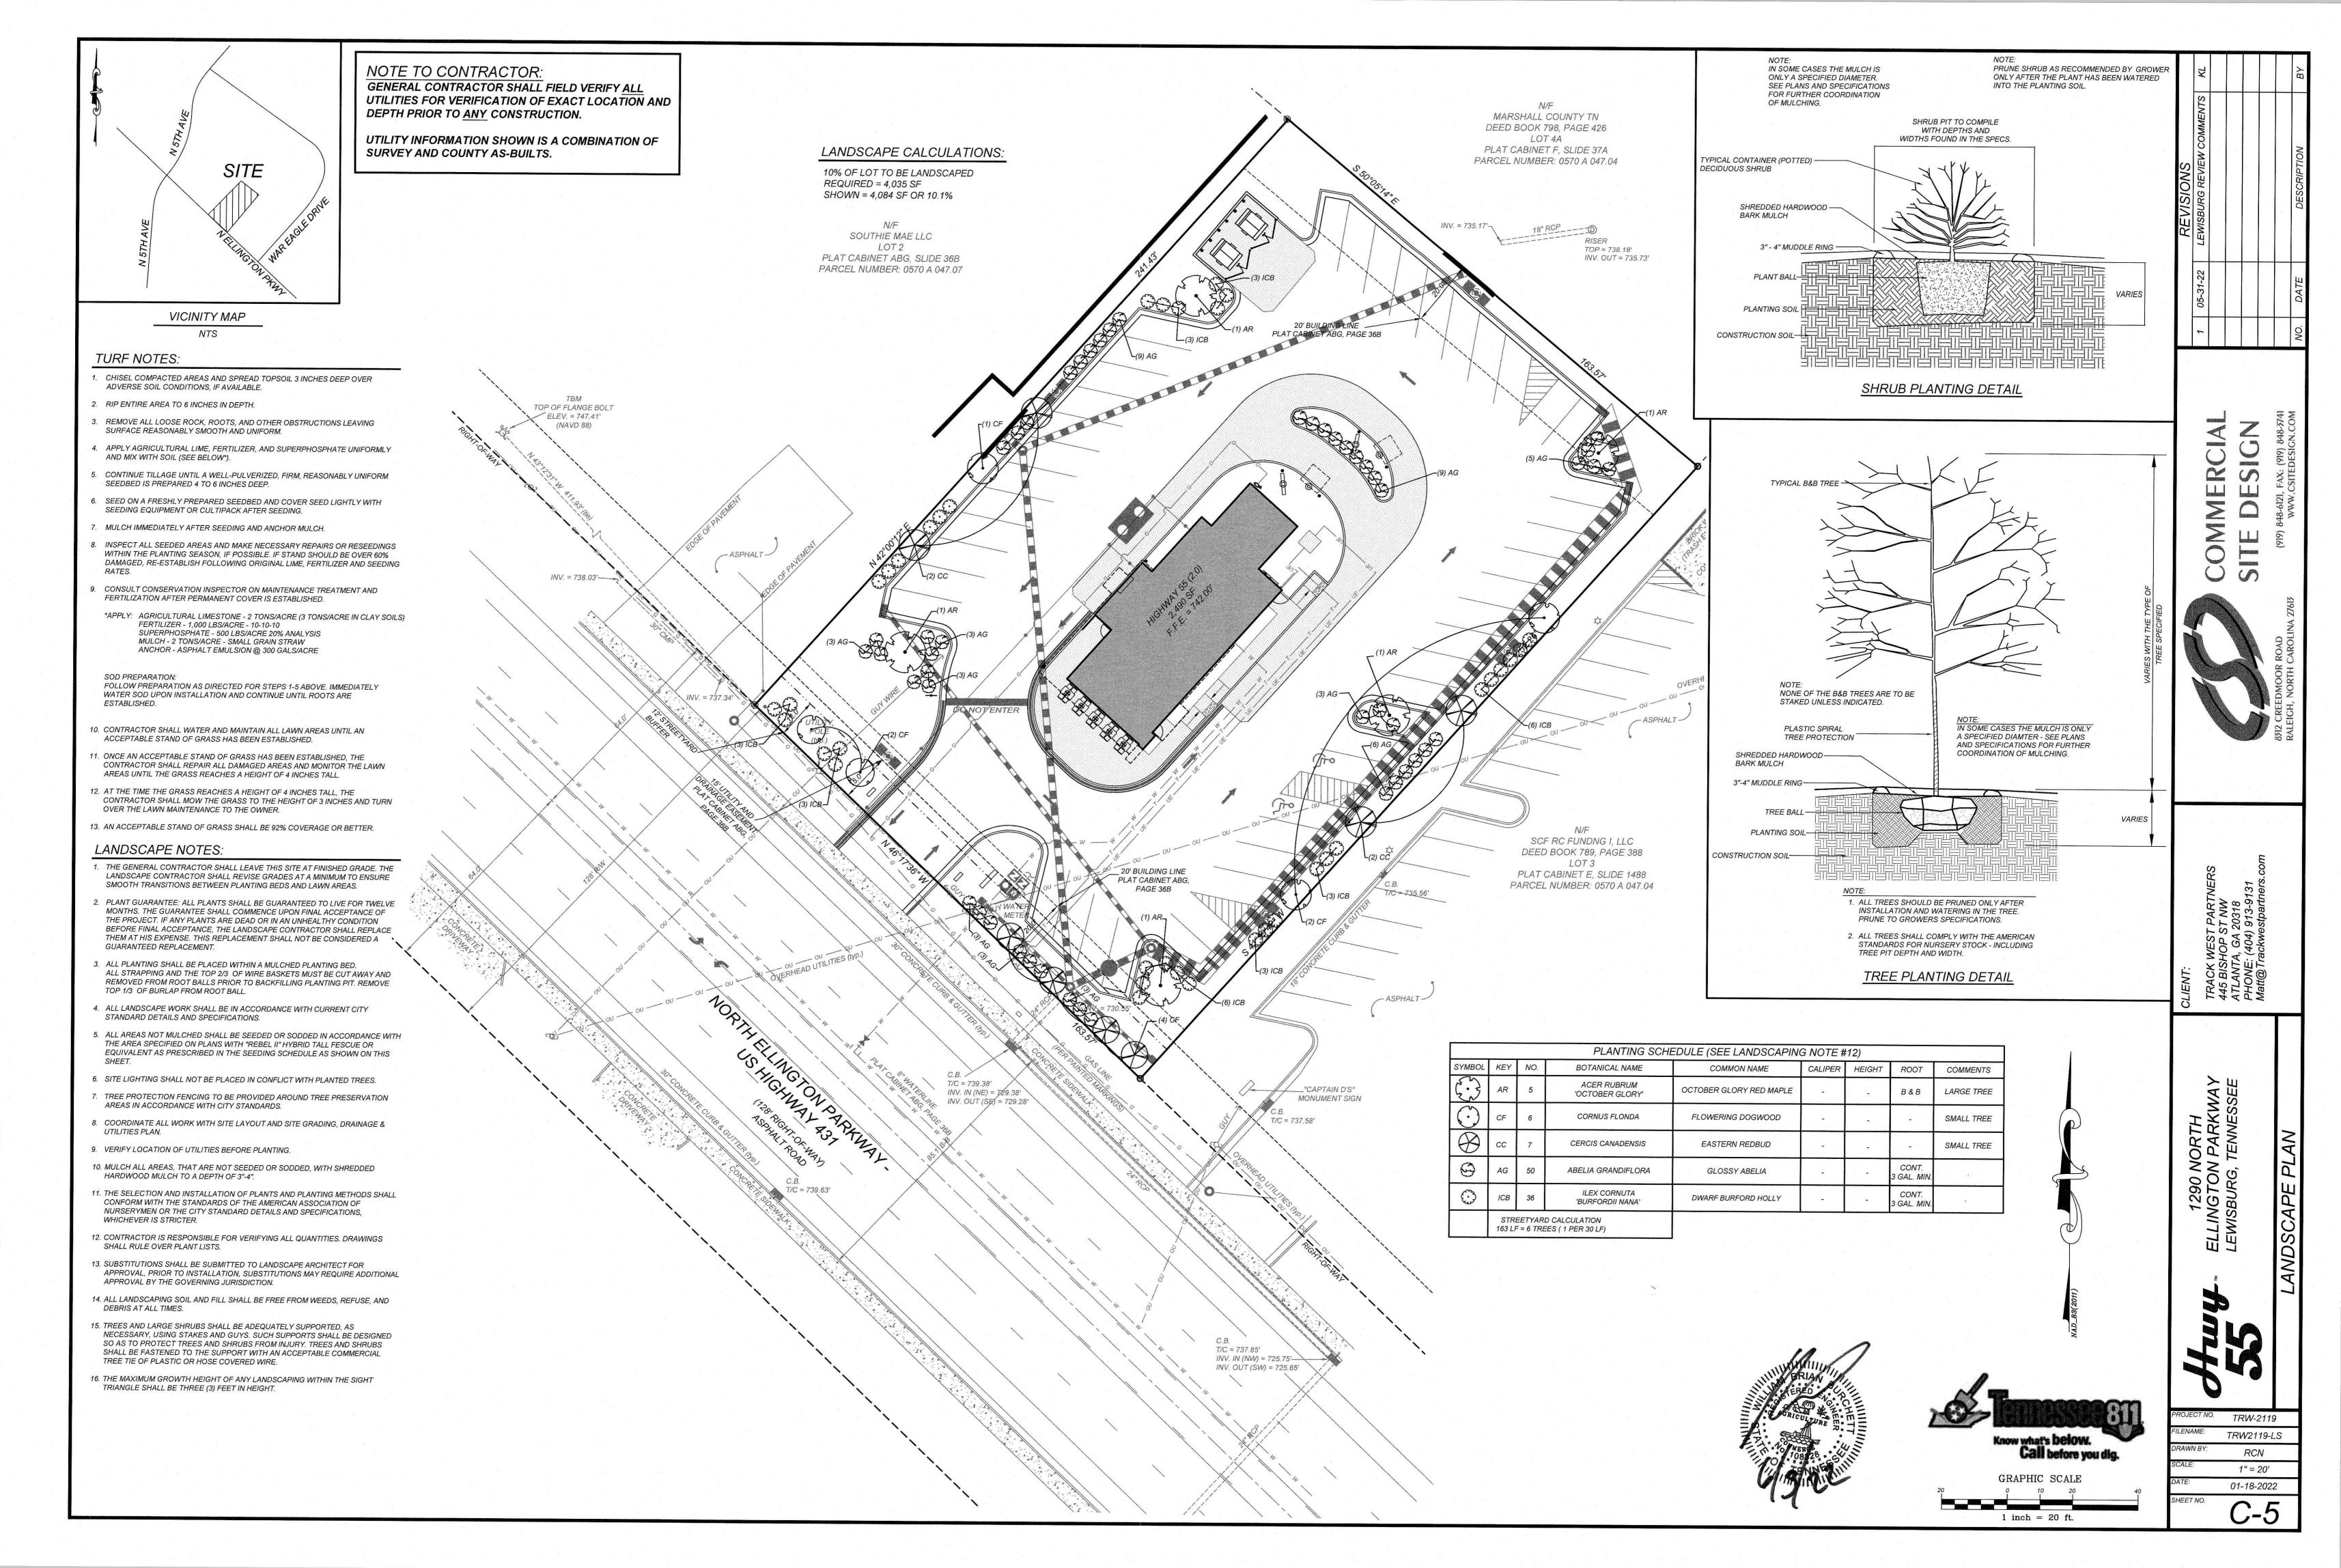TEMPORARY SEDIMENT

POOL-

CONCRETE BLOCK

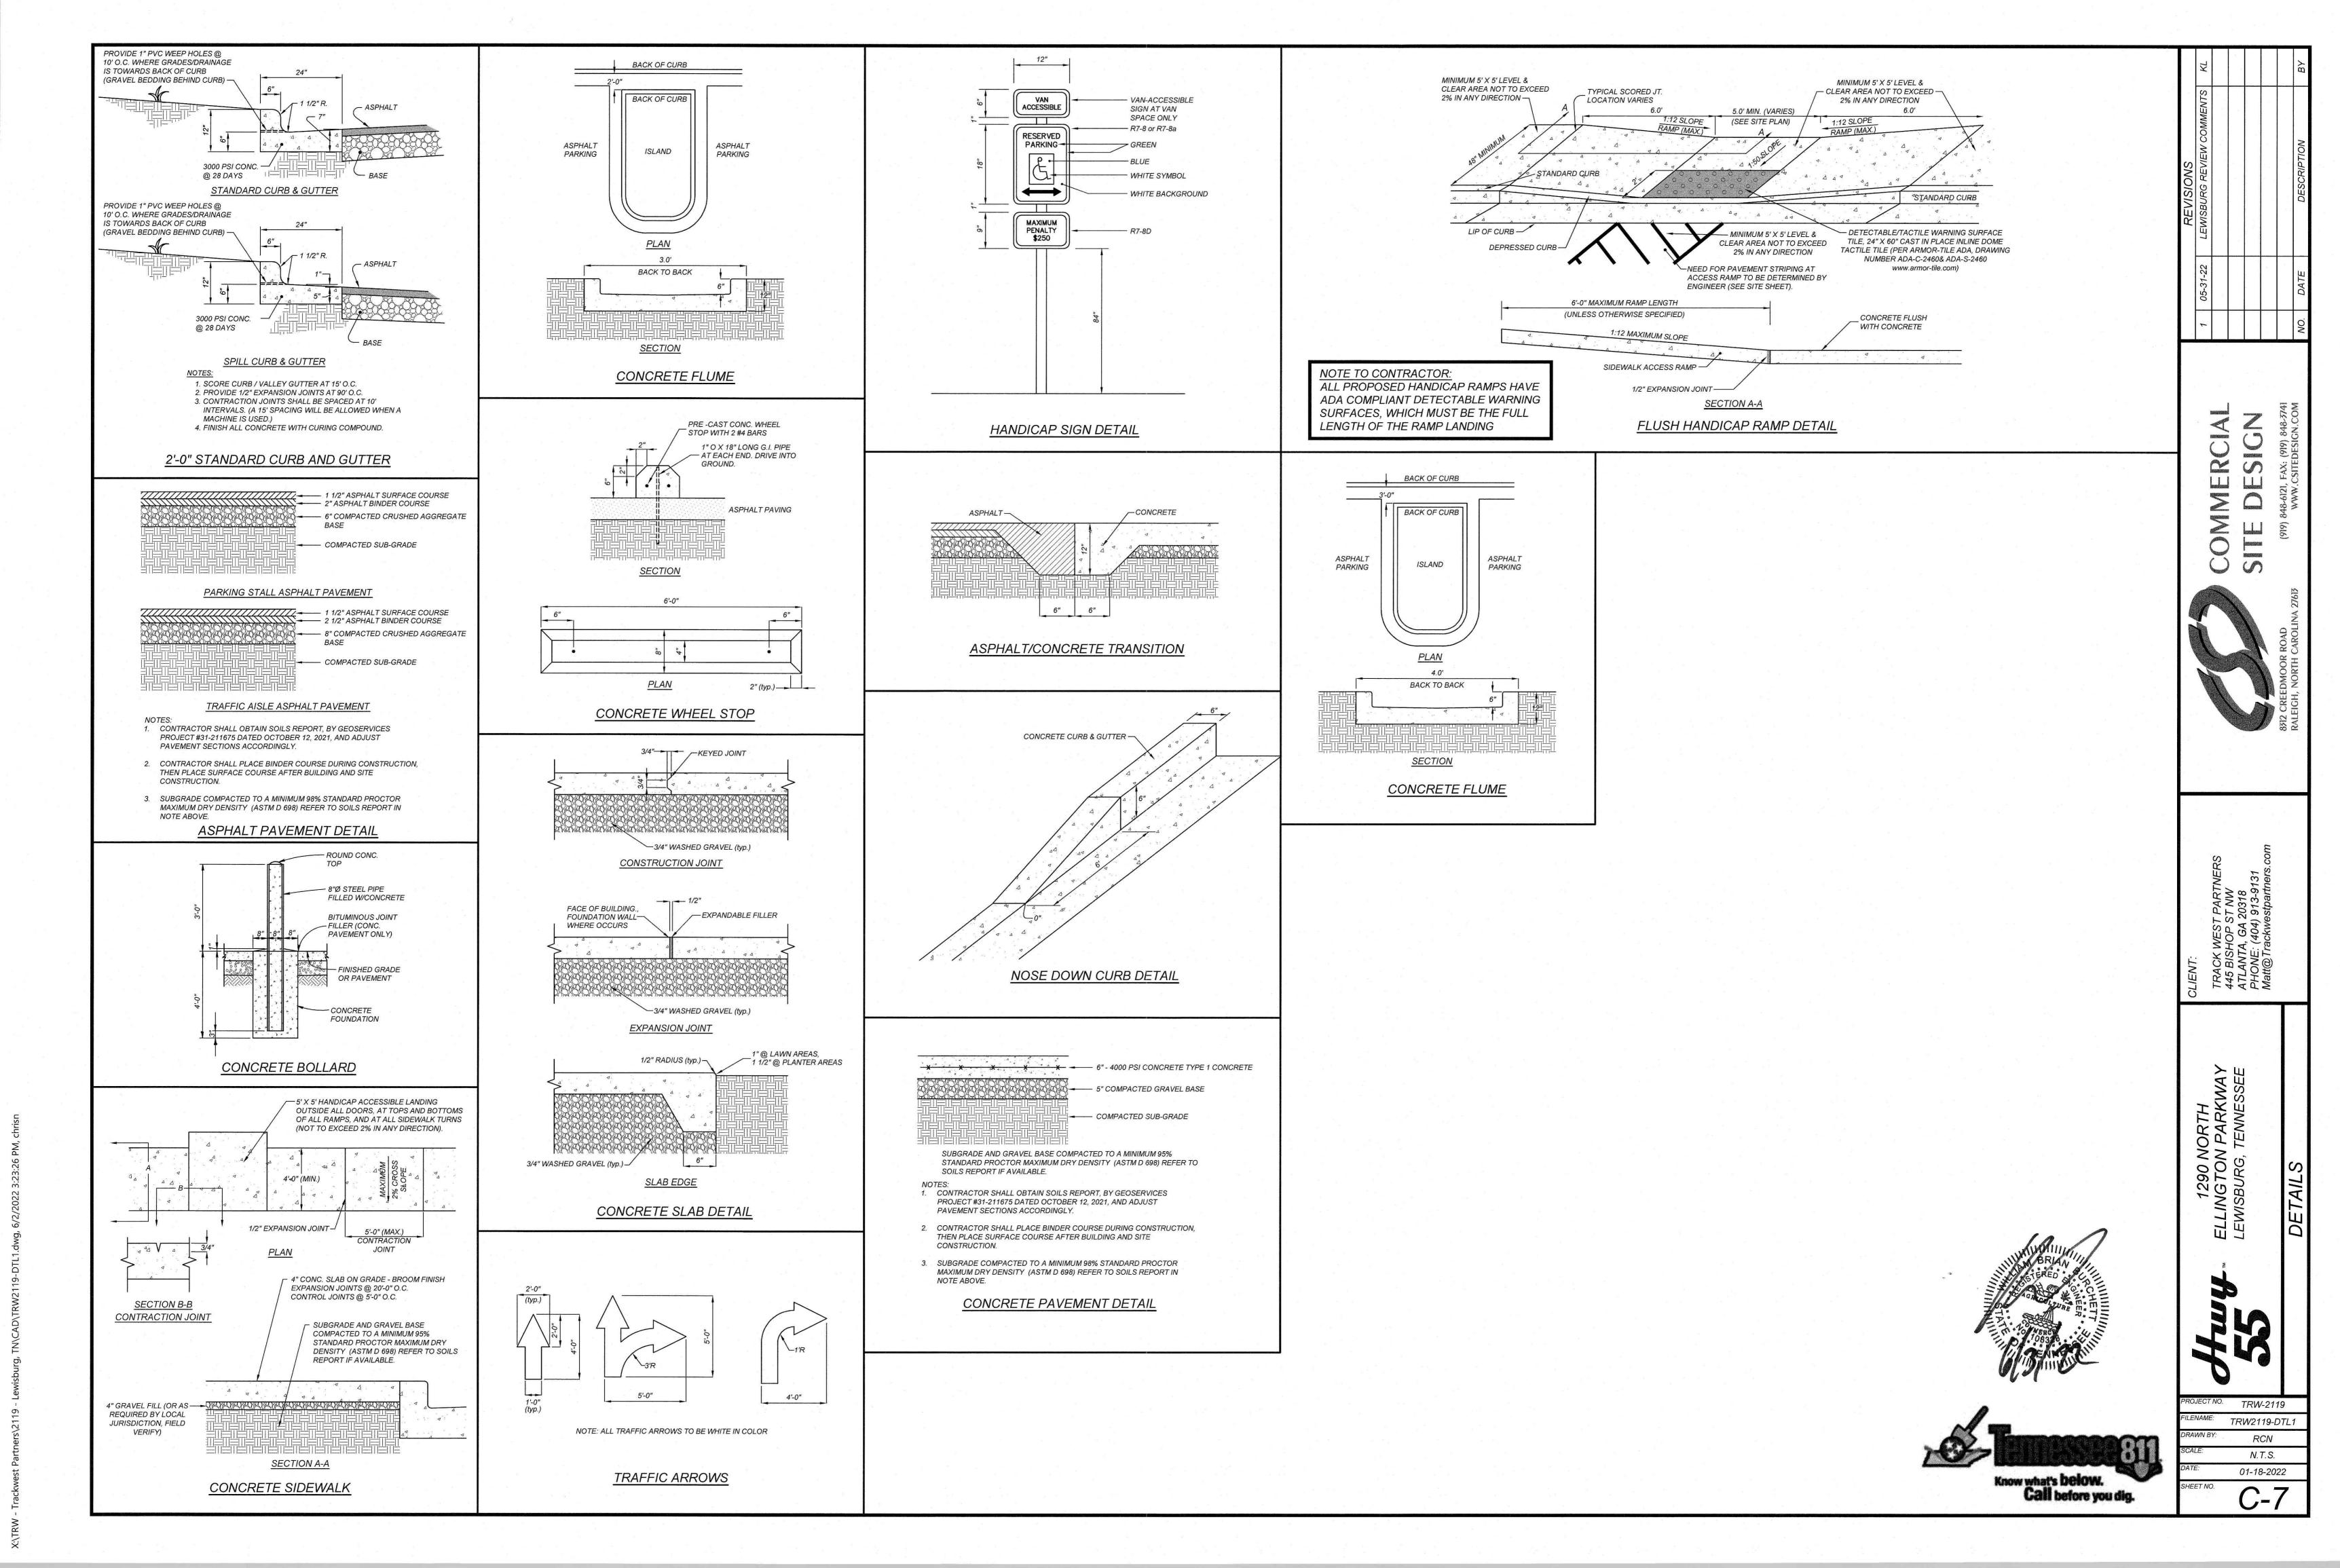2:1 SLOPE, GRAVEL FILTER

CONSTRUCTION SPECIFICATIONS

1. LAY ONE BLOCK ON EACH SIDE OF THE STRUCTURE ON ITS SIDE IN THE BOTTOM ROW TO ALLOW POOL DRAINAGE. THE FOUNDATION SHOULD BE EXCAVATED AT LEAST 2

INCHES BELOW THE CREST OF THE STORM DRAIN. PLACE THE BOTTOM ROW OF

2. CAREFULLY FIT HARDWARE CLOTH OR COMPARABLE WIRE MESH WITH 1/2-INCH

BLOCK AND GRAVEL DROP INLET PROTECTION

OPENINGS OVER ALL BLOCK OPENINGS TO HOLD GRAVEL IN PLACE.

STEEL FENCE POST-

HARDWARE CLOTH-

WIRE FENCE -

, FILTER FABRIC

#57 WASHED STONE IS RECOMMENDED.

FILTER OF 1" DIA. WASHED STONE-

BLOCKS AGAINST THE EDGE OF THE STORM DRAIN FOR LATERAL SUPPORT AND TO


AVOID WASHOUTS WHEN OVERFLOW OCCURS. IF NEEDED, GIVE LATERAL SUPPORT


TO SUBSEQUENTROWS BY PLACING 2 X 4 WOOD STUDS THROUGH BLOCK OPENINGS.

3. USE CLEAN GRAVEL, 3/4- TO 1/2-INCH IN DIAMETER, PLACED 2 INCHES BELOW THE TOP


OF THE BLOCK ON A 2:1 SLOPE OR FLATTER AND SMOOTH IT TO AN EVEN GRADE. DOT

- WIRE SCREEN

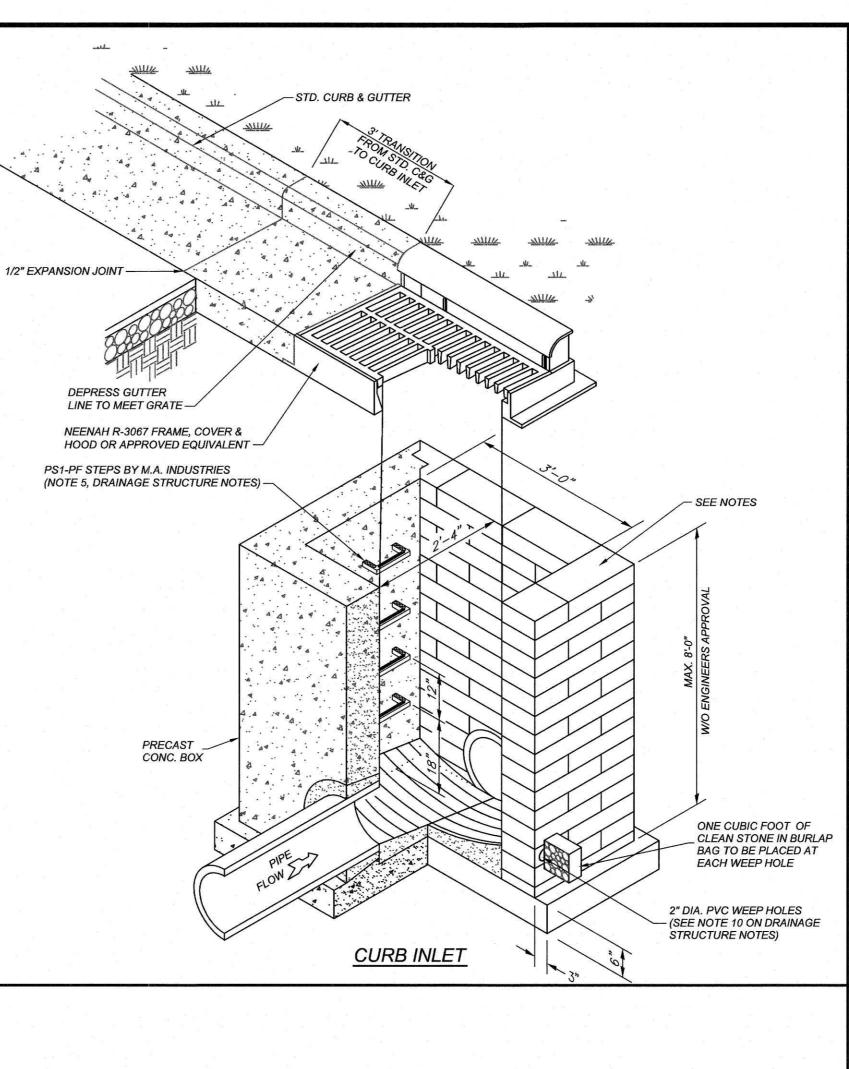

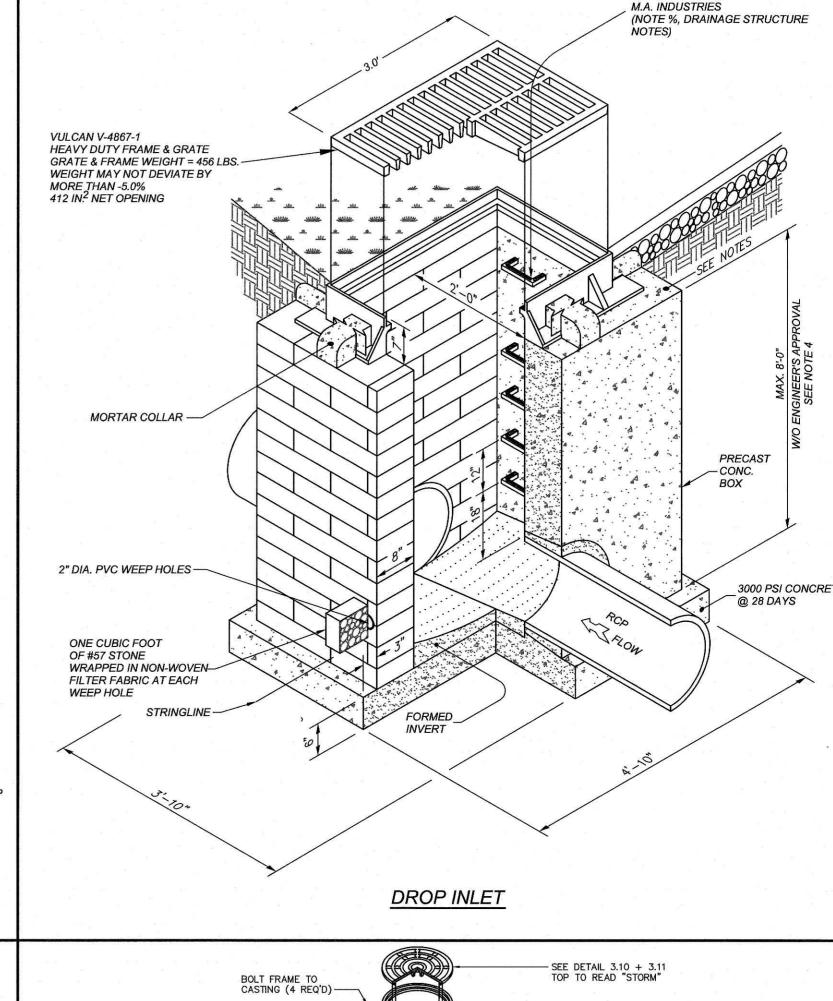

PS1-PF STEPS BY

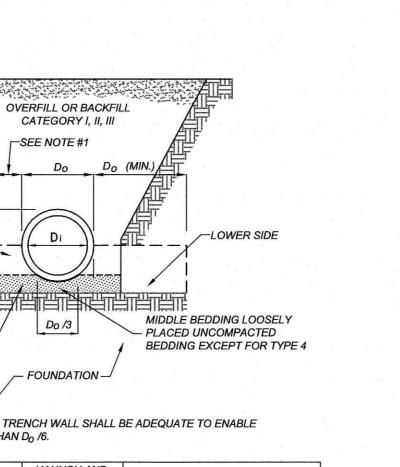

NOTE 1: CLEARANCE BETWEEN PIPE AND TRENCH WALL SHALL BE ADEQUATE TO ENABLE SPECIFIC COMPACTION, BUT NOT LESS THAN Do /6. INSTALLATION HAUNCH AND BEDDING THICKNESS LOWER SIDE D<sub>0</sub>/24 MINIMUM; NOT LESS THAN | 95% CATEGORY I | UNDISTURBED NATURAL SOIL WITH 3 IN. IF ROCK FOUNDATION, USE FIRMNESS EQUIVALENT TO THE FOLLOWING PLACED SOILS: 90% Do/12 MINIMUM; NOT LESS THAN CATEGORY I, 95% CATEGORY II, OR 100% CATEGORY III, OR EMBANKMENT TO THE SAME REQUIREMENTS.

- COMPACTION AND SOIL SYMBOLS, THAT IS, 95% CATEGORY I, REFER TO CATEGORY I SOIL MATERIAL WITH A MINIMUM STANDARD PROCTOR COMPACTION OF 95%.
- THE TRENCH TOP ELEVATION SHALL BE NO LOWER THAN 0.1 H BELOW FINISHED GRADE OR, FOR ROADWAYS, ITS TOP SHALL BE NO LOWER THAN AN ELEVATION OF 1 FT BELOW THE BOTTOM OF THE PAVEMENT BASE MATERIAL.
- 3. WHEN THE TRENCH WIDTH SPECIFIED MUST BE EXCEEDED, THE ENGINEER SHALL BE NOTIFIED.

HAUNCH -

OUT BEDDING MATERIAL AND -


COMPACTION EACH SIDE, SAME


REQUIREMENTS AS HAUNCH

- SOIL IN BEDDING AND HAUNCH ZONES SHALL BE COMPACTED TO AT LEAST THE SAME COMPACTION AS SPECIFIED FOR THE MAJORITY OF SOIL IN THE BACKFILL ZONE.
- 5. THE TRENCH WIDTH SHALL BE WIDER THAN SHOWN IF REQUIRED FOR ADEQUATE SPACE TO ATTAIN THE SPECIFIED COMPACTION IN THE HAUNCH AND BEDDING ZONES.
- 6. FOR TRENCH WALLS THAT ARE WITHIN 10 DEGREES OF VERTICAL, THE COMPACTION FIRMNESS OF THE SOIL IN THE TRENCH WALLS AND LOWER SIDE ZONE NEED NOT BE CONSIDERED. SEE NOTE 3.
- FOR TRENCH WALLS GREATER THAN 10 DEGREE SLOPES THAT CONSIST OF EMBANKMENT, THE LOWER SIDE SHALL BE COMPACTED TO AT LEAST THE SAME COMPACTION AS SPECIFIED FOR THE SOIL IN BACKFILL ZONE. SEE NOTE 3.
- PRIOR TO THE PLACEMENT OF THE BACKFILL.

REQUIRED BEDDING THICKNESS IS THE THICKNESS OF THE BEDDING AFTER THE PLACEMENT OF THE PIPE ON THE BEDDING AND

TYPE I - TRENCH DETAIL

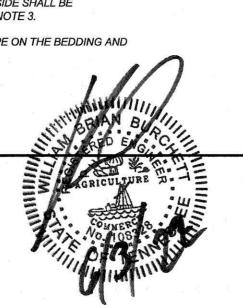

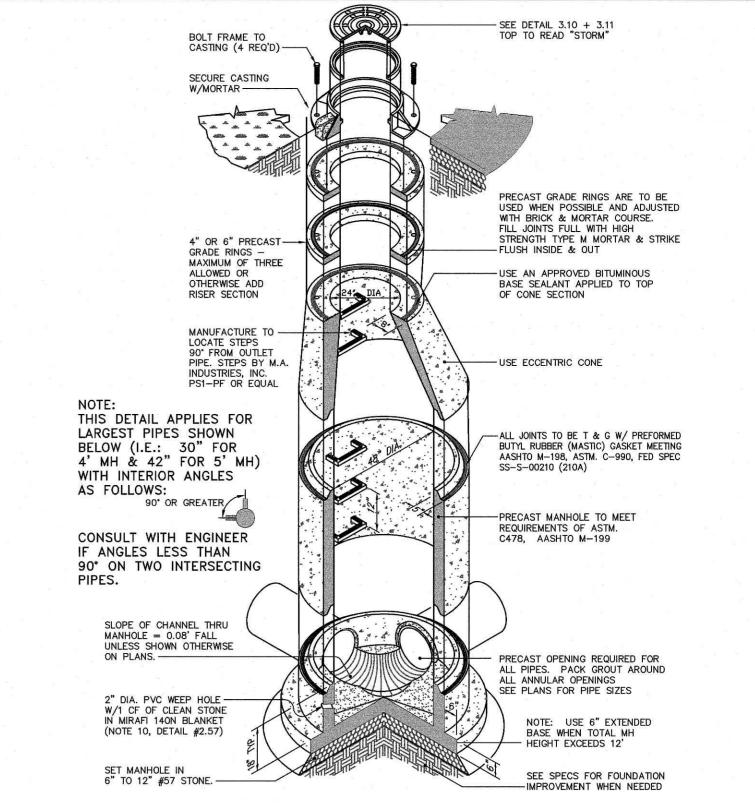

# DRAINAGE STRUCTURE NOTES

- 1. BOXES SHALL COMPLY WITH LOCAL JURISDICTIONAL STANDARDS AND SPECIFICATIONS.
- ANY NONSTANDARD BOX IS TO BE DESIGNED BY A PROFESSIONAL ENGINEER.
- 3. THE MAXIMUM HEIGHT OF AN UN-REINFORCED MASONRY DRAINAGE STRUCTURE WITH 8" WALLS SHALL BE LIMITED TO 8'-0" FROM INVERT OF THE OUTLET PIPE TO THE TOP OF THE CASTING. DEPTHS GREATER THAN 8'-0" SHALL HAVE WALLS 12" THICK. BASINS OVER 12' IN TOTAL DEPTH SHALL BE DESIGNED BY A PROFESSIONAL ENGINEER. FOUR INCH WALLS ARE NOT ALLOWED ON DRAINAGE STRUCTURES. BOTTOM SLAB ON STRUCTURES SHALL BE REINFORCED WHEN BOX DEPTHS EXCEEDS 8 FT.


STORM MANHOLE

- 4. STEPS ARE TO BE PROVIDED ON ALL BASINS DEEPER THAN 42".
- 5. STEPS ARE TO BE PS1-PF AS MANUFACTURED BY M.A. INDUSTRIES OR AN APPROVED EQUAL. LOCATE ON NON-PIPE WALLS.
- MORTAR IN MASONRY BOXES IS TO BE TYPE M. 7. CLAY BRICK STRUCTURES ARE NOT ALLOWED.
- 8. CONCRETE PIPE IS TO BE MINIMUM CLASS III.
- 9. CONCRETE BUILDING BRICK IS TO MEET ASTM C-55, GRADE N, TYPE 1. 10. BASINS LOCATED IN WET AREAS, OR AS OTHERWISE REQUIRED BY THE TOWN ENGINEER, SHALL HAVE WEEP HOLES AS SHOWN ON DETAILS.
- 11. ALL CAST-IN-PLACE PRECAST CONCRETE DRAINAGE STRUCTURES LOCATED IN PAVED AREAS ACCESSIBLE TO TRUCK LOADINGS TO BE DESIGNED TO MEET AASHTO HS 20-44 LOADING. SEE MANUFACTURERS DETAILS FOR WALL, TOP AND BOTTOM THICKNESS.

1290 NORT ELLINGTON PAF LEWISBURG, TENI

TRW-2119 TRW2119-DTL2 RCN N.T.S. 01-18-2022



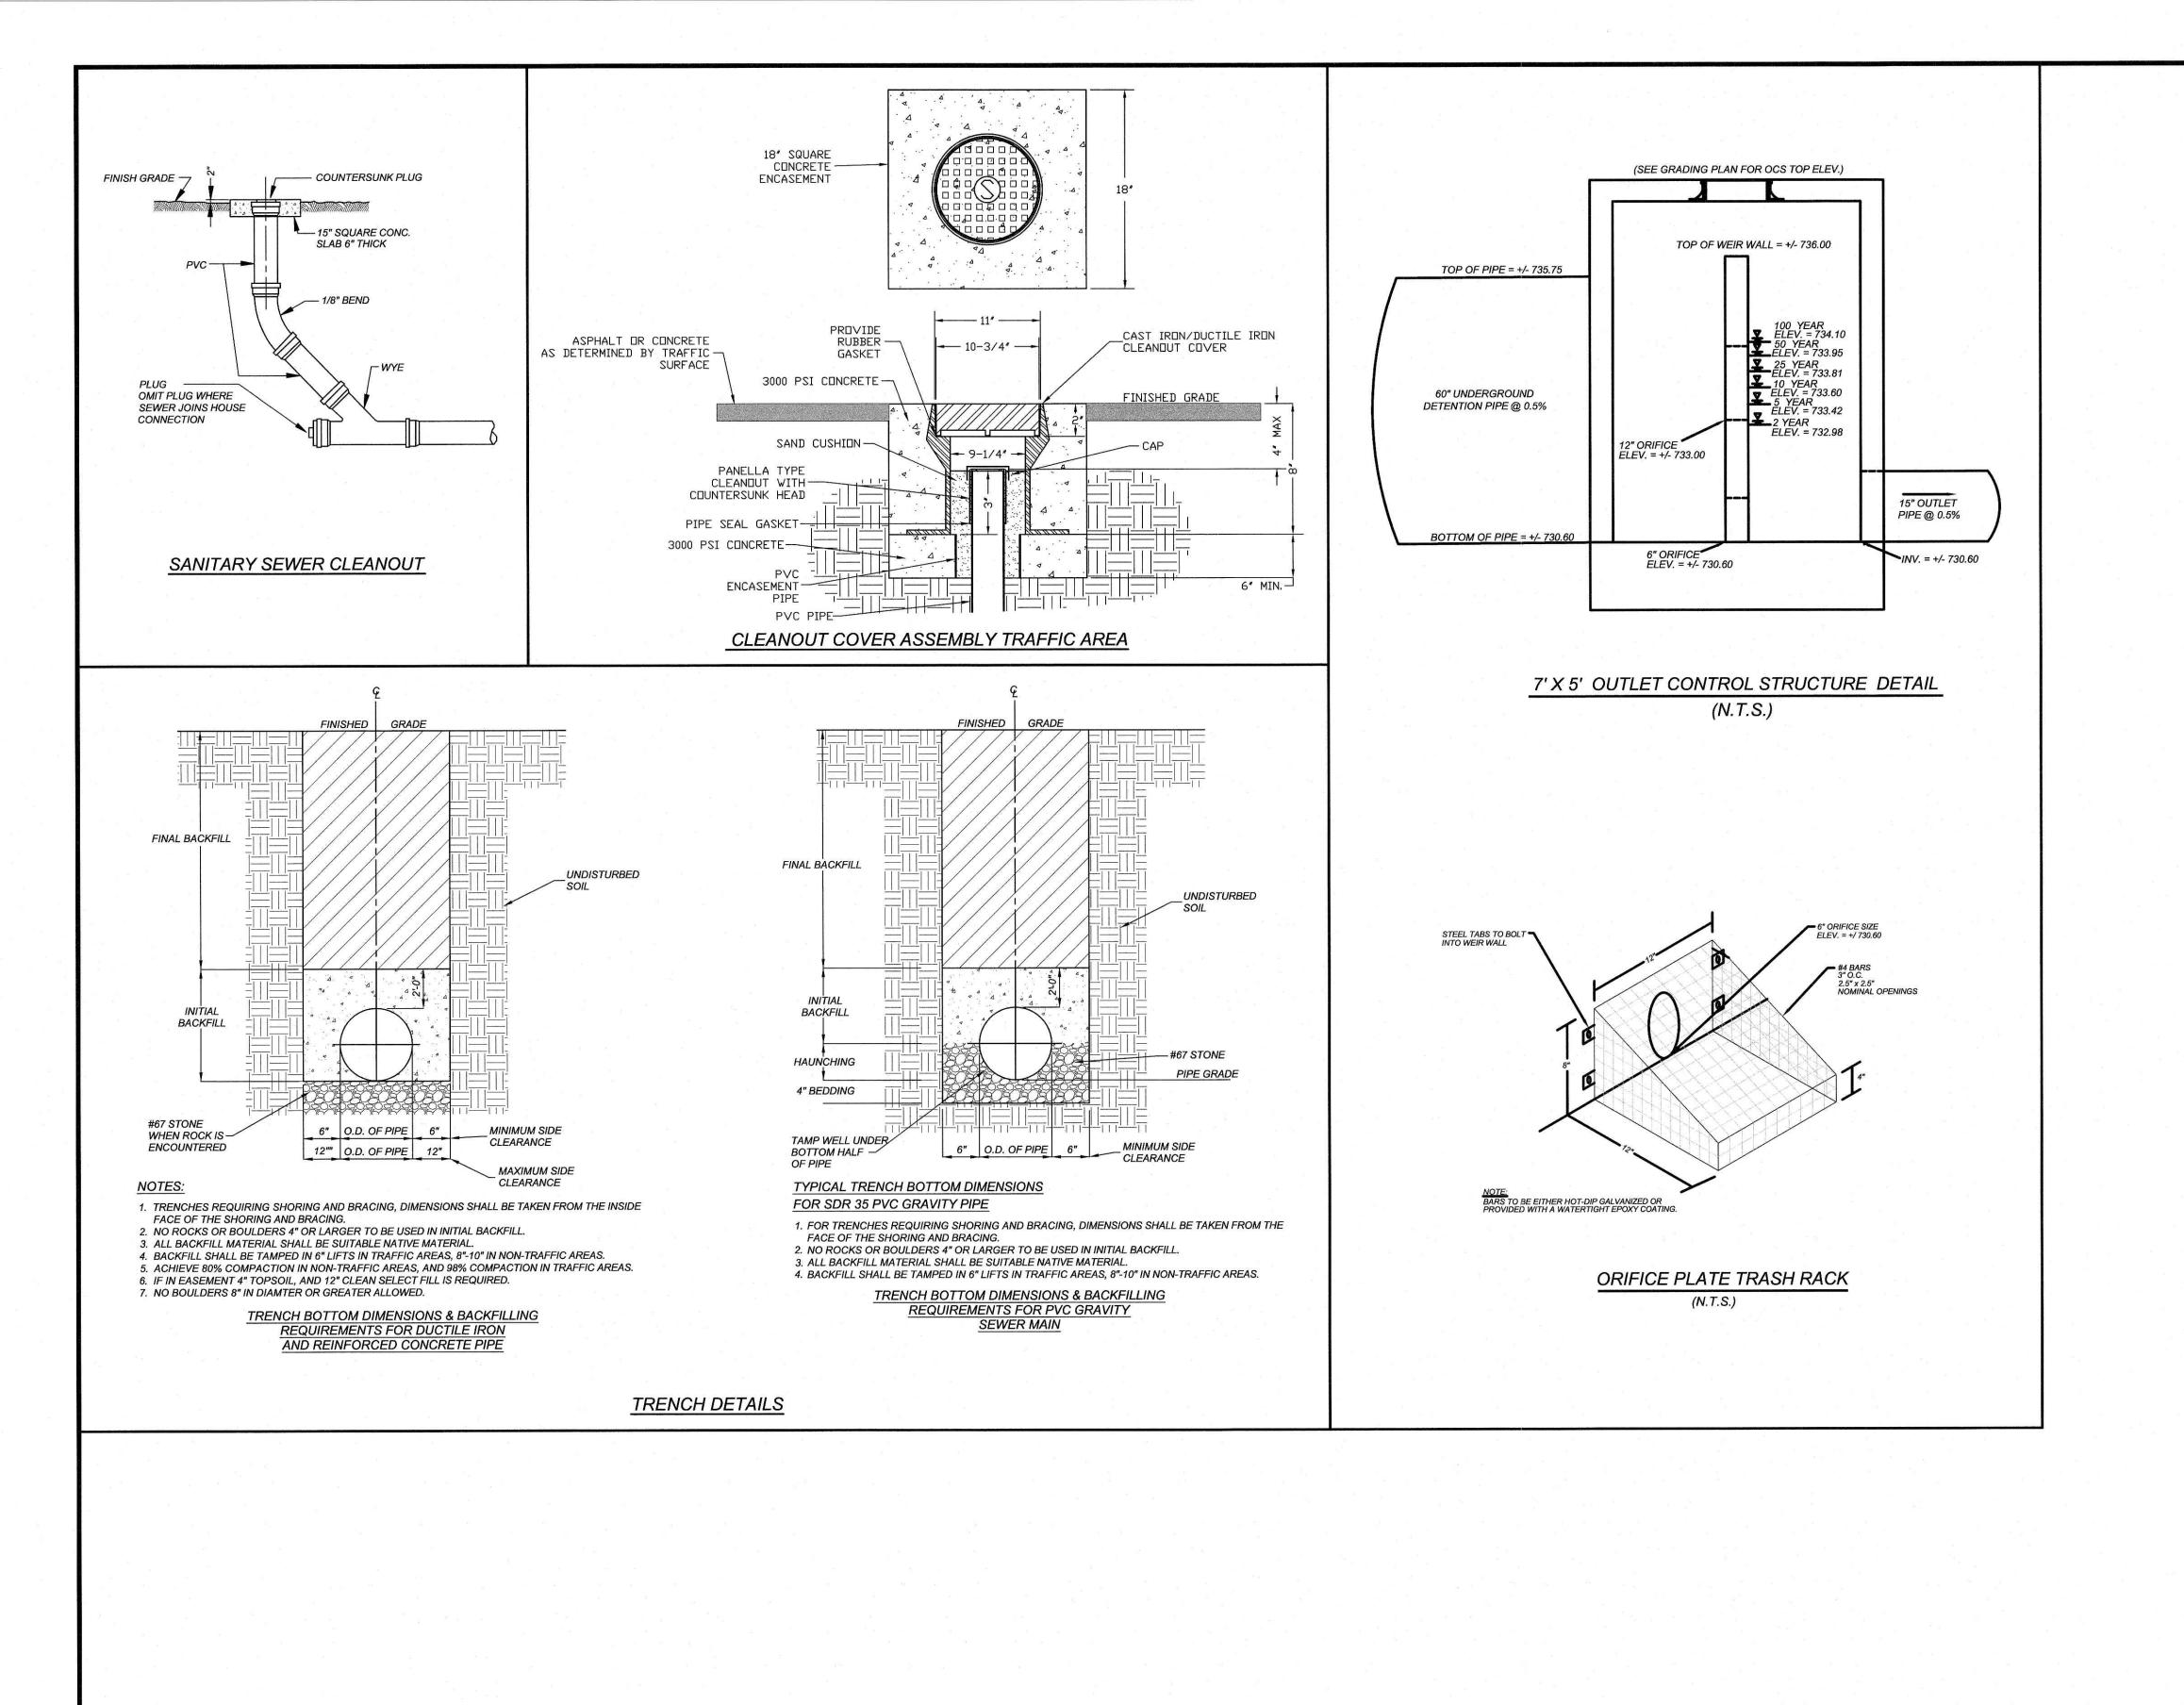





REVISIONS

REVISIONS

REVISIONS

1 05-31-22 LEWISBURG REVII

S G N

X: (919) 848-3741

NO. DATE DESCRIPT

8712 CREEDMOOR ROAD RALEIGH, NORTH CAROLINA 27


445 BISHOP ST NW ATLANTA, GA 20318 PHONE: (404) 913-9131 Matt@ Trackwestpartners.com

ELLINGTON PARKWAY LEWISBURG, TENNESSEE

**35** 


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VN BY: RCN
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01-18-2022 **C-9** 

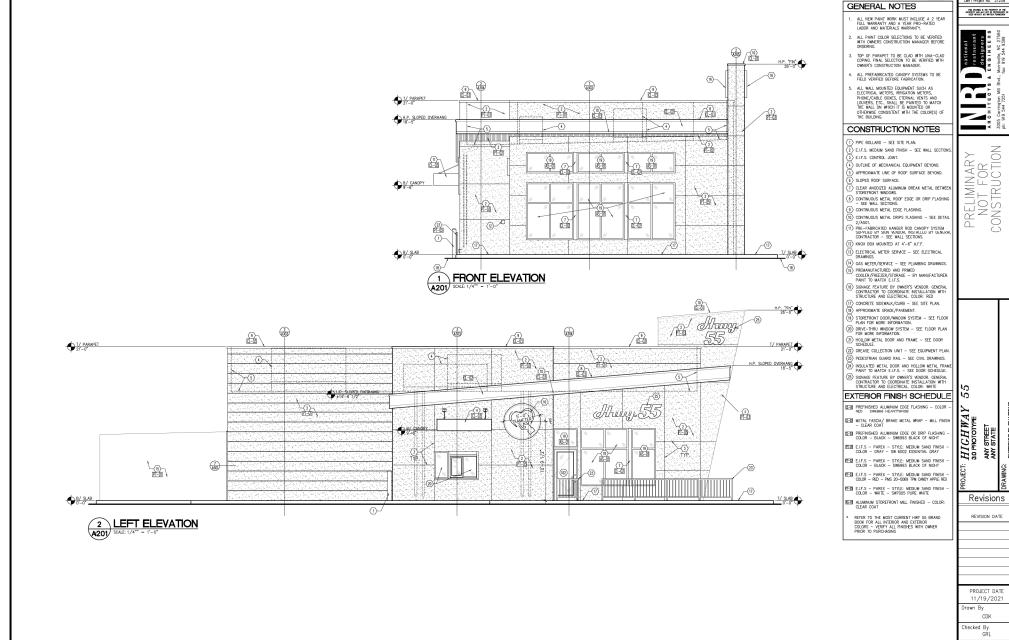

Sheet No.

A201

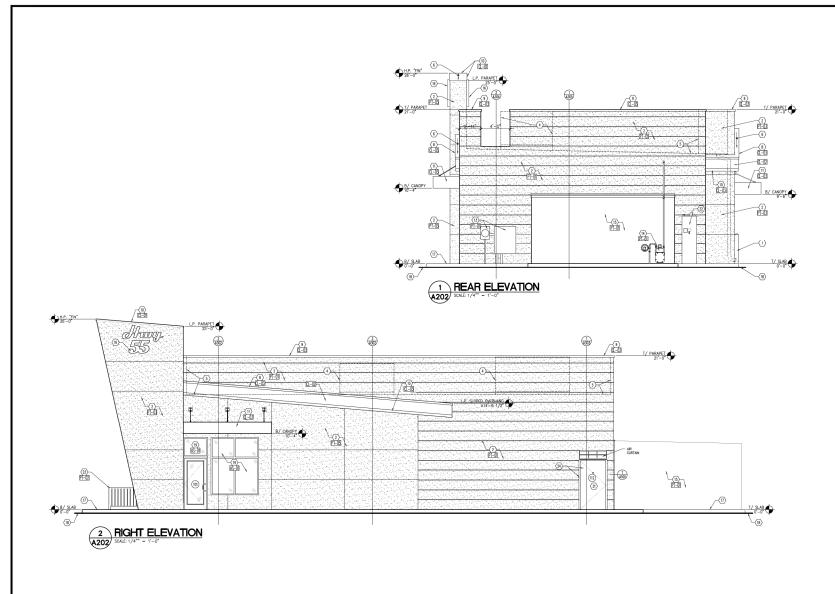

### GENERAL NOTES

- ALL NEW PAINT WORK MUST INCLUDE A 2 YEAR FULL WARRANTY AND A YEAR PRO-RATED LABOR AND MATERIALS WARRANTY.
- TOP OF PARAPET TO BE CLAD WITH UNA-CLAD COPING, FINAL SELECTION TO BE VERIFIED WITH OWNER'S CONSTRUCTION MANAGER.
- ALL PREFABRICATED CANOPY SYSTEMS TO BE FIELD VERIFIED BEFORE FABRICATION.
- 5. ALL WALL MOUNTED EOUIPMENT SUCH AS ELECTRICAL METERS, RRIGATION METERS, PHONE/CABLE BOXES, FERNAL VENTS AND LOUVERS, ETC., SHALL BE PAINTED TO MATCH THE WALL DO WHIGH IT IS MOUNTED OR OTHERWISE CONSISTENT WITH THE COLOR(S) OF THE BULLDHE.

### CONSTRUCTION NOTES

- 1) PIPE BOLLARD SEE SITE PLAN.
- 2 E.I.F.S. MEDIUM SAND FINISH SEE WALL SECTION: 3 E.I.F.S. CONTROL JOINT.
- 4) OUTLINE OF MECHANICAL EQUIPMENT BEYOND.
- APPROXIMATE LINE OF ROOF SURFACE BEYOND.
   SLOPED ROOF SURFACE.
- 7 CLEAR ANODIZED ALUMINUM BREAK METAL BETWEEN STOREFRONT WINDOWS.
- STOREFRONT INTODORS.
   SOCITINUOUS METAL ROOF EDGE OR DRIP FLASHING
   SEE WALL SECTIONS.
- SEE WALL SECTIONS.

  (3) CONTINUOUS METAL EDGE FLASHING.
  (8) CONTINUOUS METAL DIRPS FLASHING SEE DETAIL
  (7) ASOL.
  (1) PRICE-PARICATED HANGER ROD CANOPY SYSTEM
  SUPPLIED BY SOLFMANDER, RESTALLD BY GAMMAL
  CONTRACTOR SEE WALL SECTIONS.
- (12) KNOX BOX MOUNTED AT 4'-6" A.F.F. (13) ELECTRICAL METER SERVICE - SEE ELECTRICAL
- MAWNOS.

  (M) GAS METER/SERVICE SEE PLUMBING DRAWINGS.

  (IS) PREMANUFACTURED AND PRIMED

  COOLER/FREEZER/STORAGE BY MANUFACTURER.
  PAINT TO MATCH (E.I.F.S.)
- (16) SIGNAGE FEATURE BY OWNER'S VENDOR, GENERAL CONTRACTOR TO COORDINATE INSTALLATION WITH STRUCTURE AND ELECTRICAL, COLOR: RED

- STRUCTURE AND ELETTRICAL COLOR- RED

  (17) CONCRETE SEGNANC/CORE SES ET FLAN.

  (8) APPRODUNATE GRADE/PACEIDIT.

  PLAN FOR MORE SEGNANCION.

  (2) DEPRE-TRIBU MOROW SYSTEM SEE FLOOR PLAN.

  FOR MORE REFORMATION.

  (2) SHOLDEN MELT DOOR MOR FRAME SEE DOOR PLAN.

  (3) SHOLDEN MELT DOOR MOR FRAME SEE DOOR SEGNALE.

  (3) SHEADER MELT DOOR MOR FRAME SEE DOOR SERVES COLLECTION UNIT SEE EQUIPMENT PLAN. (23) PEDESTRIAN GUARD RAIL - SEE CIVIL DRAWINGS.
- 24 INSULATED METAL DOOR AND HOLLOW METAL FRAM PAINT TO MATCH E.I.F.S. SEE DOOR SCHEDULE.
- (25) SIGNAGE FEATURE BY OWNER'S VENDOR, GENERAL CONTRACTOR TO COORDINATE INSTALLATION WITH STRUCTURE AND ELECTRICAL, COLOR: WHITE

### EXTERIOR FINISH SCHEDULE

- PREFINISHED ALUMINUM EDGE FLASHING COLOR RED SW6866 HEARTTHROB
- U-III METAL FASCIA/ BRAKE METAL WRAP MILL FINIS CLEAR COAT
- PREFINISHED ALUMINUM EDGE OR DRIP FLASHING COLOR BLACK SW6993 BLACK OF NIGHT
- ELIF.S PAREX STYLE: MEDIUM SAND FINISH COLOR GRAY SW 6002 ESSENTIAL GRAY
- PER E.I.F.S PAREX STYLE: MEDIUM SAND FINISH COLOR BLACK SW6993 BLACK OF NIGHT
- PEG E.I.F.S PAREX STYLE: MEDIUM SAND FINISH -COLOR RED PMS 20-0069 TPM CANDY APPLE RED
- PEG E.I.F.S PAREX STYLE: MEDIUM SAND FINISH COLOR WHITE SW7005 PURE WHITE
- ALUMINUM STOREFRONT MILL FINISHED COLOR: REFER TO THE MOST CURRENT HWY 55 BRAND BOOK FOR ALL INTERIOR AND EXTERIOR COLORS — VERFY ALL FINISHES WITH OWNER PRIOR TO PURCHASING

THE DRIVING IS THE PROPERTY OF THE ARCHIECT AND MAY NOT BE ADMISSION ON USES WEIGHT AS MINTEN PERMISSION

NOT FOR CONSTRUCTION IMINAR

HICHWAS ANY

Revisions


REVISION DATE

PROJECT DATE 11/19/2021

CDK Checked By

Sheet No.

A202

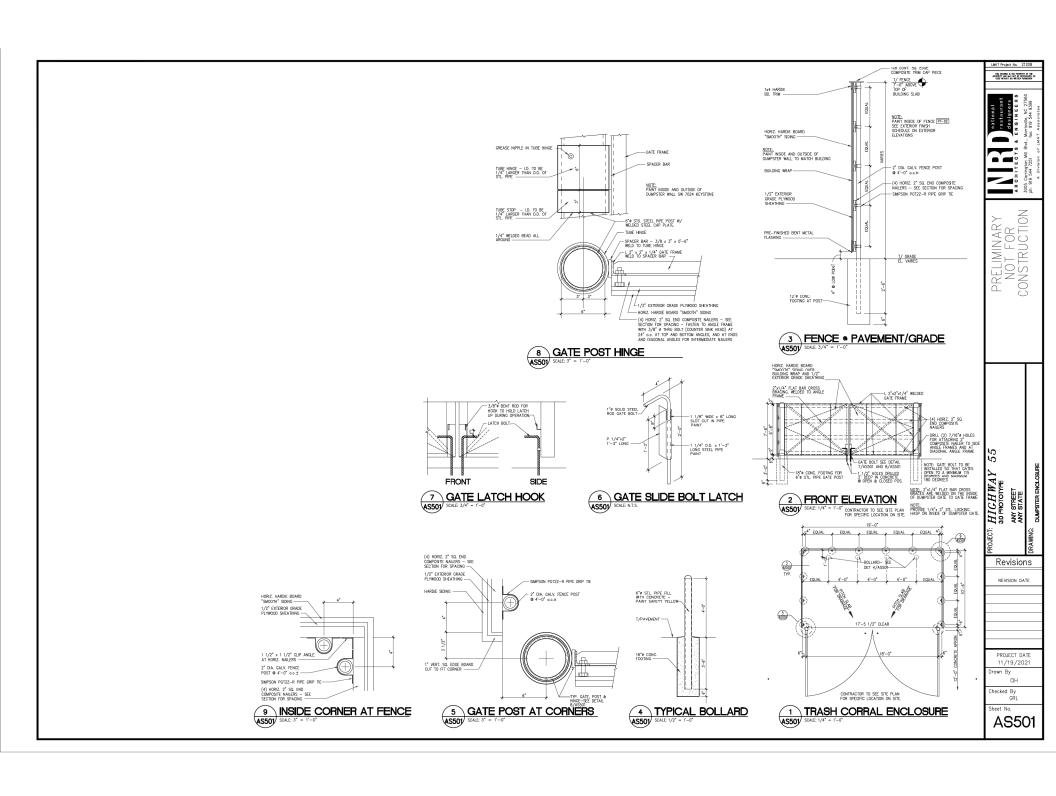

INTERIOR TABLE/SEAT CALCULATION					
ITEM	DESCRIPTION	FURINITURE SEATING OUANTITY QUANTITY			
80	BAR STOOL	8	8		
82	2 TOP TABLE - 24X48	3	6		
82HC	4 TOP ADA TABLE - 30X48	2	8		
85	BOOTH - 30X48	9	36		
TOTAL		22	58		

\*THIS SEATING ARRANGEMENT ACCOMMODATES 14 TABLES

EXTERIOR TABLE/SEAT CALCULATION						
ITEM	DESCRIPTION	FURNITURE CUANTITY	SEATING QUANTITY			
87	OUTDOOR - 30X48	2	8			
87HC	OUTDOOR - 30X48 - ADA	1	4			
87A	OUTDOOR - 36" ROUND TABLE	3	12			
87AHC	OUTDOOR - 36" ROUND ADA	1	4			

\*THIS SEATING ARRANGEMENT ACCOMMODATES 7 TABLES

### GENERAL NOTES

- 1 PVC CHASE BY G.C. FOR SODA LINES COORDINATE WITH SODA VENDER
- SURFACE MOUNTED FIRE EXTINGUISHER / FIRE EXTINGUISHER CABINET IN THE DINING.
- WALK-IN COOLER / FREEZER w/INTERGRAL CONDENSERS MOUNTED ON UNIT.
- LOW VOLTAGE CONDUIT TO EQUIPMENT FOR LOW VOLTAGE SYSTEM G.C. TO INSTALL COORDINATE WITH EQUIPMENT SUPPLIER
- (5) INSULATED FLOOR / SLAB BY EQUIPMENT VENDOR
- HAND SINK SEE PLUMBING DRAWINGS
- 4"x4" SQ. CHASE FOR OIL SYSTEM G.C. TO INSTALL COORDINATE w/EQUIPMENT SUPPLIER.
- PROVIDE 1 1/4" BLACK IRON PIPE UP THROUGH WALLS / CEILING FOR WASTE OIL RECOVERY SYSTEM 9 CONNECTION FOR GREASE / OIL WASTE
- SHELVING DESK TO HAVE SOLID S.S. TOP AT  $34^{\circ}$  A.F.F. WITH SHELVES ABOVE DESK EXACT SPEC BY THE TENANT.

### **GENERAL NOTES**

- ALL FURNITURE TO BE SELECTED AND PROVIDED BY OWNER COORDINATE WITH EQUIPMENT SCHEDULE
- 2. G.C. TO COORDINATE ALL CLEARANCES REQUIRED FOR EQUIPMENT AND MILLWORK WITH EQUIPMENT SUPPLIER.
- ALL CABINETS / COUNTERTOPS ARE INCLUDED IN THE EQUIPMENT PACKAGE. GC ONLY TO COORDINATE FIELD DIMENSIONS WITH SUPPLIER.
- , VERIFY ALL SHELVING AND WORK TABLES QUANTITIES WITH OWNER.
- 5. REFER TO SHEET Q600 FOR EQUIPMENT SCHEDULING.
- S TAILES SOFTEL CORNER GUARD/DIO CAPS SHALL BE PROVIDED & INSTALLED ON ALL BACK OF THE HOUSE CORNERS AND END CAPS SEE SHEET AITH FOR LOCATIONS.

  1. LOCATE REMOTE WALK—IN FREZEZE/COLOLER CONDICISER ON MAIN FLAT ROOF. SEE MECHANICAL DRAWINGS. C.C. CODISIONALE POWER PROUMERUNTS AND PHYNO WY COCCEP SUPPLIER AND INSTALLER.

птем отту.	DESCRIPTION	ITEM OTY	OTY.	DESCRIPTION	Dani Tropec No. 2	1200	
1	3	HAND SINK w/2 SPLASHGUARDS	34A	2	SS TABLE W/ SHELF BELOW 24"x36"	THE DEMAND IS THE PROPERTY OF THE MEDITED AND MAY NOT BE REPRODUCED ON USES WINDOW AS WRITTEN PERMISSION	
2	1	1-DOOR FREEZER	348	1	SS TABLE w/SHELF BELOW 24"x48"		
3	4	REFRIG. PREPBOX - 29"W	34C	3	SS TABLE W/ SHELF BELOW 30"x36"		999
3A	4	24"W SHELVES - CANTILEVERED	34D	1	SS TABLE w/SHELF BELOW 30"x48"	national restaurant designers NGINEER	Morrisville, NC 27560 fax: 919 544 9399
4	6	FRYER	34F	1	SS TABLE w/SHELF BELOW 18*x36*	ne ign	2 4 4 ×
5	1	GRIDDLE	34G	2	SS TABLE w/SHELF BELOW 18"x42"	national restaura designer	919
5A	1	GRIDDLE	34H	1	SS TABLE W/SHELF BELOW 18"x60"	ı Z	Morri
6	1	REFRIG. CHEFBASE - 48"W	35	4	POS TERMINAL SYSTEM	•	Blvd.
6A	1	REFRIG. CHEFBASE - 36"W	35A	1	DROP SAFE - UNDERCOUNTER	° E	- B
7	3	TRASH CAN	36A	2	STORAGE RACK - 24x48		251 M
8	2	WARMING STATION	36D	5	STORAGE RACK - 24x72		15 Carrington   919 544 7251
9	2	WORKTOP FREEZER	36E	2	STORAGE RACK - 18x48		50.00
11	2	STEAMER	36F	9	F/C STORAGE RACK - 18x48		3005 ph: 9
12	2	COOKER/WARMER	37	1	VEGGIE SINK W/ RH DRAIN		, u.
13	2	REFRIG. PREPBOX - 60"W	38	1	3-COMPARTMENT SINK	ł	
14A	7	MONITOR	39A	1	WALL-MOUNTED WIRE SHELVES - 48°W	_	=
14B	1	BUMPBAR	39B	4	WALL-MOUNTED WIRE SHELVES - 36"W	l & ⊆	_
14C	7	PRINTER	39C	2	WALL-MOUNTED WIRE SHELVES - 24"W	1 A R L	_
16	2	HOOD SYSTEM	41	1	CAN WASH	LIMINARY OT FOR	ζ.
18	1	REFRIG. PREPBOX	42	1	MODULAR BIB RACK	1 =	2
19	1	MIX-IN BLENDER	43	1	CO2 TANK		=
20	1	COOKER/WARMER	44	1	BREAD RACK	L교으	7
21	2	DIPPER WELL	46	2	ICE MACHINE W/ FLAKER HEAD		_
22	2	DIPPING CABINET	46A	1	ICE BIN - 800LB		2
24	1	FROZEN CUSTARD MACHINE	47A	1	OUTSIDE WALK-IN DRY STORAGE	_	_1
25	1	EQUIPMENT STAND	47C	1	OUTSIDE WALK-IN COOLER (BUILT w/#47F)	ł	
26	2	SODA MACHINE	47F	1	OUTSIDE WALK-IN FREEZER (BUILT w/#47C)	ł	
27	2	CUP DISPENSER	48	1	2-DOOR COOLER	ł	
28	3	TEA URN	50	1	USED OIL CONTAINER	ł	
29	2	JUICER	51	1	CAN OPENER	ł	
30	4	3-GAL DRINK DISPENSER	52	1	EMPLOYEE CUBBIES	ł	
31	1	1-GALLON WATER PITCHER	53	2	SHELF 48'W X 12"D - MNTD TO #9		
32	2	WALL MOUNTED BIB KETCHUP DISPENSER	55	1	WATER FILTRATION SYS. W/DOOSTER PUMP	ł	ı
33	1	COFFEE/TEA BREWER	56	1	MOVABLE RACK SYSTEM	l	ı
34	2	SS TABLE w/SHELF BELOW 24"x30"	57	1	CONVECTION OVEN	l	ı
			58	4	TRENCH DRAIN	l	ı

2 HALF HEIGHT STORAGE RACK - 18x36

BISCUIT RACK

DINING CHAIRS

ADA TABLE - 30"x48"

BOOTH BENCH - DOUBLE

OUTDOOR TABLE 30"x48"

BOOTH TABLE - 30"x48"

OUTDOOR TABLE 36" ROUND ADA

OUTDOOR TABLE 30"x48" - ADA

SEMI RECESSED FIRE EXTINGUISHER

INSTANTANEOUS WATER HEATER

IT EQUIPMENT SHELVING UNIT WALL MOUNTED CONIDMENTS

FIRE EXTINGUISHER

PUBLIC TRASH BIN

AIR CURTAIN

65

87AHC

80 8 BAR STOOL

81A 8 LOW CHAIRS

82 3 2 TOP TABLE

83 6 BOOTH BENCH - END

86 26 OUTDOOR CHAIRS

90A 2 FIRE EXTINGUISHER


97 1 TO GO RACK

SERVICE SINK FAUCET

UTILITY SHELF MOP RACK

ELECTRIC 2-SIDED CLAMSHELL GRILL

HALF HEIGHT STORAGE RACK - 18x48

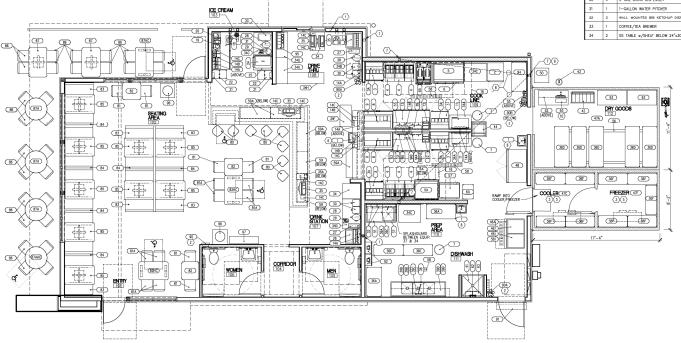

1 EQUIPMENT PLAN

HIGHWAY 30 PROTOTYPE AM₹

3

Revisions REVISION DATE

PROJECT DATE

11/19/2021 MTP

Checked By

Sheet No. Q111

## SIGN A Highway 55 HWY 55 | Exterior Sign Elevation | Pylon with Vacuum For Illuminated Pylon Sign Internally Illuminated w/ LED's Square Footage: 12'-0" 24" 1-1/2" 1-1/2" Extruded aluminum sign cabinet Internally illuminated w/ White LED's and power supplies 6'-0" Cabinet retainers and returns to be painted black per specifications **BURGERS CHEESESTEAKS SHAKES DRIVE THRU** 1-1/2" depth Pan face with 1/2" Embossed Copy 5" deep with single white face illuminated cabinet laminated vinyl copy Steel support pipe 25'-0" OAH Pole Cover Dimensions: .080" Thick Aluminum Pole cover 48"width x 14" depth Painted SW 6258 Black Pole Decorations: Bars painted to match: 19'-0" VACUUM FORMED PAN FACE PMS 20-0069 TPM Candy Apple Red RGB - 178.0.0 CMYK - 21.100.100.14 Huy55 14" Wide Pole Cover 1-1/2" Raised vacuum Final Grade Pan FACE SECTION A-A with embossed copy FOOTING MAY BE UP TO 6" BELOW GRADE. UNDISTURBED SOIL - 10" Diameter Steel support pipe PRIMARY ELECTRICAL PROVIDED BY GC NOT IN SIGN CONTRACT 9 42000 PSI Concrete Augered (Caisson) Footing 3'-0" (Typical) 3'-0"



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Customer Approval Landford Approval: