


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WPN 21.0592
Lewisburg Dental Clinic
APPROVED FOR CONSTRUCTION
THE DOCUMENT BEARING THIS STAMP HAS BEEN RECEIVED AND REVIEWED BY THE
TENNESSEE DEPT. OF ENVIRONMENT & CONSERVATION
DIVISION OF WATER RESOURCES
AND IS HEREBY APPROVED FOR CONSTRUCTION BY THE COMMISSIONER
Michael J. Swanson
August 23, 2021
THIS APPROVAL SHALL NOT BE CONSTRUED AS CREATING A
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COMMISSIONER THAT THE APPROVED FACILITIES WILL REACH THE
DESIGNED GOALS.
APPROVAL EXPIRES ONE YEAR FROM ABOVE DATE

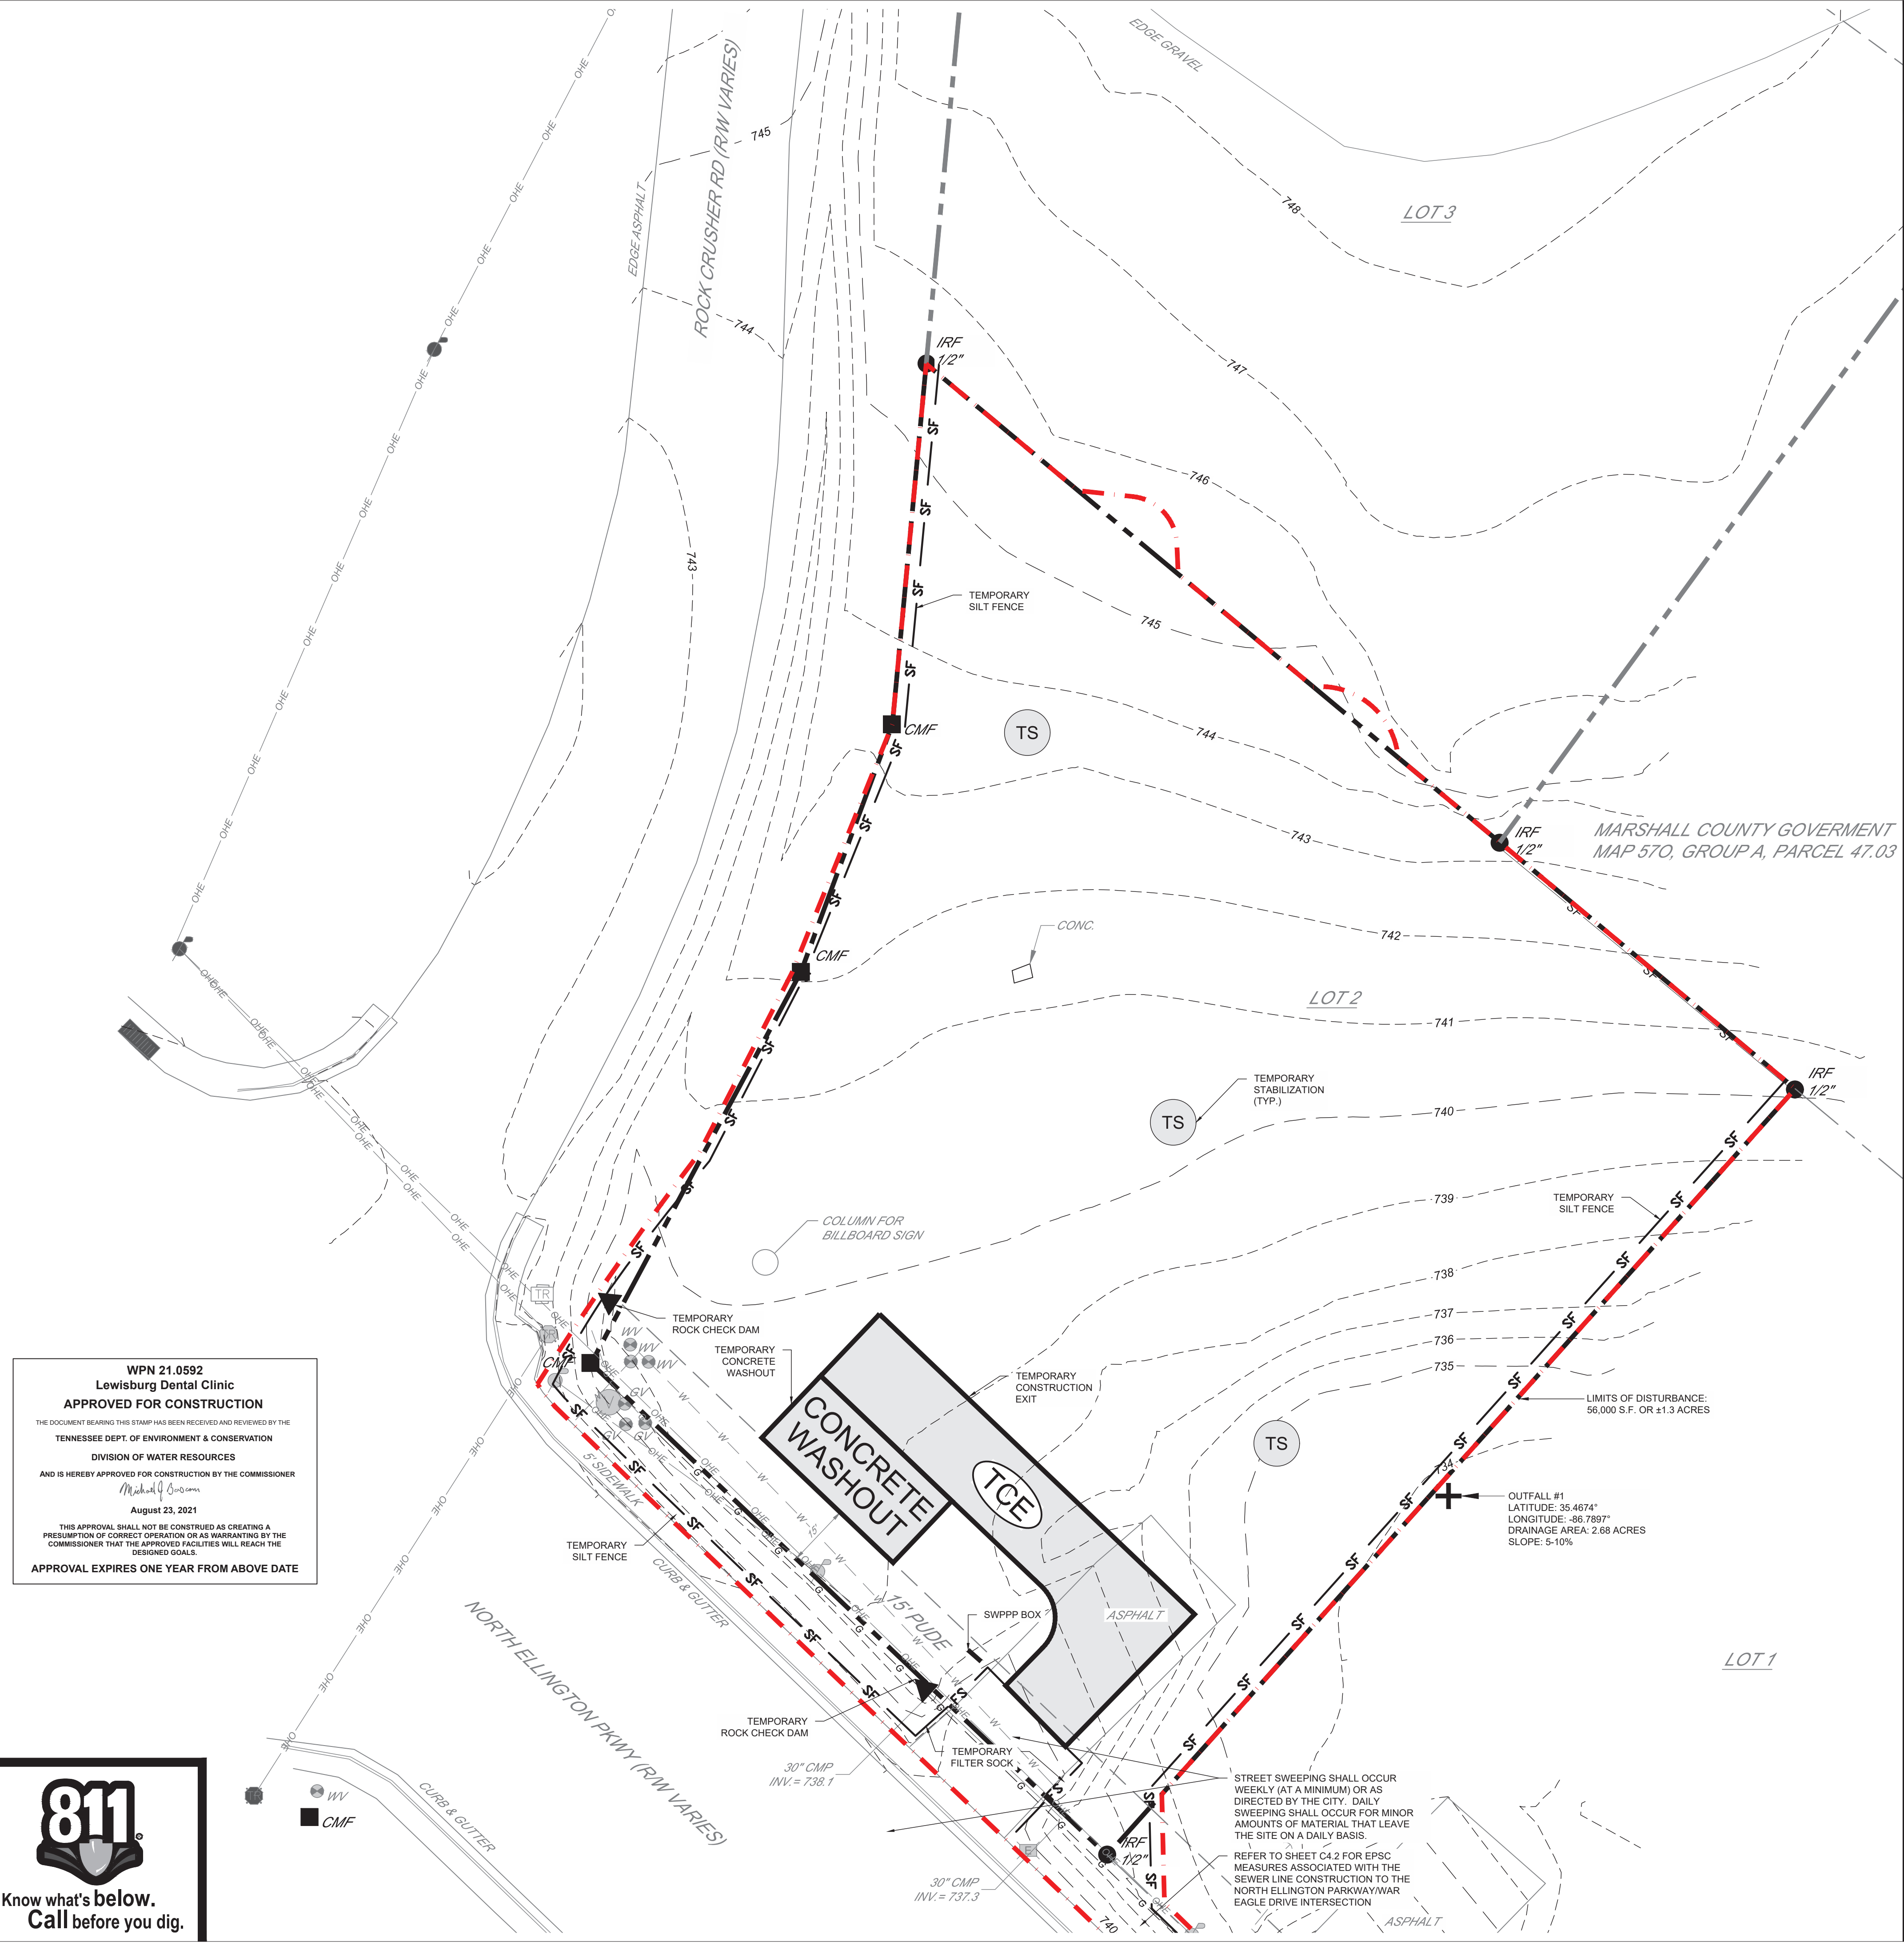

LEGEND:

---	EXISTING PROPERTY LINE	---	PROPOSED AREA DRAIN
---	EXISTING ADJACENT PROPERTY LINE	---	PROPOSED HEADWALL
---	EXISTING EASEMENT	---	PROPOSED CONTOURS
---	EXISTING INDEX CONTOUR	---	PROPOSED STORM PIPE
---	EXISTING INTERMEDIATE CONTOUR	---	PROPOSED STORM CLEANOUT
---	EXISTING WATER LINE	---	LIMITS OF DISTURBANCE
---	EXISTING OVERHEAD ELECTRIC	---	SILT FENCE OR FILTER SOCK
●	IRON REBAR FOUND (IRF)	---	TEMPORARY CONSTRUCTION EXIT
■	CONCRETE MONUMENT FOUND (CMF)	---	TEMPORARY CONSTRUCTION EXIT
○	BENCHMARK	---	TEMPORARY ROCK CHECK DAM
○	EXISTING CATCH BASIN	---	TEMPORARY STABILIZATION
○	EXISTING SANITARY MAN-HOLE	---	TEMPORARY INLET PROTECTION
○	EXISTING WATER BOX (WATER VALVE)	---	STORMWATER OUTFALL
○	EXISTING WATERLINE MARKER		
○	EXISTING GAS BOX (GAS VALVE)		
○	EXISTING GAS VENT		
○	EXISTING POWER POLE		
○	EXISTING GUY WIRE		
○	EXISTING TRAFFIC POLE		
○	EXISTING TRAFFIC SIGNAL BOX/CABINET (ABOVE GRADE)		
○	EXISTING SIGN		

- REFERENCE:**
- SEE SHEET C0.1 FOR GENERAL NOTES AND EROSION AND SEDIMENT CONTROL NOTES.
 - BOUNDARY, TOPOGRAPHIC AND UTILITY INFORMATION SHOWN IS BASED ON A FIELD-RUN TOPOGRAPHY CONDUCTED BY M2 GROUP, LLC, RECEIVED IN APRIL 2021.
 - THE PROPERTY SHOWN HEREON IS LOCATED IN A FLOOD HAZARD ZONE "X" (AREAS DETERMINED TO BE OUTSIDE OF THE 0.2% ANNUAL CHANCE FLOODPLAIN) ACCORDING TO F.I.R.M. MAP "MARSHALL COUNTY, TENNESSEE" PANEL 158 OF 325, MAP NUMBER 47117C0158D, REVISED SEPTEMBER 28, 2007.

NOTE:
CONTRACTOR SHALL REFER TO THE GEOTECHNICAL EXPLORATION REPORT, PREPARED BY ECS SOUTHEAST, LLP, ECS PROJECT NO. 26-4743, DATED APRIL 1, 2021 FOR ALL GEOTECHNICAL RECOMMENDATIONS. THE GEOTECHNICAL EXPLORATION REPORT SHALL BE CONSIDERED AN INTEGRAL PART OF THE BID PACKAGE.

STREET SWEEPING SHALL OCCUR WEEKLY (AT A MINIMUM) OR AS DIRECTED BY THE CITY. DAILY SWEEPING SHALL OCCUR FOR MINOR AMOUNTS OF MATERIAL THAT LEAVE THE SITE ON A DAILY BASIS.
REFER TO SHEET C4.2 FOR EPSC MEASURES ASSOCIATED WITH THE SEWER LINE CONSTRUCTION TO THE NORTH ELLINGTON PARKWAY/EAGLE DRIVE INTERSECTION

OUTFALL #1
LATITUDE: 35.4674"
LONGITUDE: -86.7897"
DRAINAGE AREA: 2.68 ACRES
SLOPE: 5-10%

LIMITS OF DISTURBANCE:
56,000 S.F. OR ±1.3 ACRES

SCALE: 1" = 20'

SURVEY INFO
PROVIDED BY: M2 GROUP, LLC
DATUM: TENNESSEE STATE PLANE (NAD83 & NAVD88)

MORELOCK ENGINEERING
2097 BELSFORD DRIVE
NOLENSVILLE, TN 37135
JASON@MORELOCKENG.COM - (615) 300-6486

H M H A
H. Michael Hindman
Architects, P.C.
1607 Westgate Circle - Suite 100
Brentwood, Tennessee 37027
615.370.5252
www.hmhaarchitects.com

SEAL: JASON C. MORELOCK, REGISTERED PROFESSIONAL ENGINEER, No. 10889, STATE OF TENNESSEE, 07/21/21

Dental Clinic
1298 NORTH ELLINGTON PARKWAY
TAX MAP 57 O, GROUP A, PARCEL 47.07, LEWISBURG, MARSHALL COUNTY, TN
SOUTHIE MAE, LLC
1601 WESTGATE CIRCLE, BRENTWOOD, TENNESSEE 37027

Revisions

HMH Job Number
20064

Drawn By
JCM

Date
07.02.21

Drawing

EPSC PLAN
STAGE I

C3.2

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WPN 21.0592
Lewisburg Dental Clinic
APPROVED FOR CONSTRUCTION


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Michael J. Cozmon
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---	EXISTING WATER LINE	---	LIMITS OF DISTURBANCE
---	EXISTING OVERHEAD ELECTRIC	---	PERMANENT EROSION CONTROL BLANKET
●	IRON REBAR FOUND (IRF)	PS	PERMANENT STABILIZATION
■	CONCRETE MONUMENT FOUND (CMF)	+	PERMANENT OUTLET PROTECTION
○	BENCHMARK	+	STORMWATER OUTFALL
○	EXISTING CATCH BASIN		
○	EXISTING SANITARY MAN-HOLE		
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MORELOCK ENGINEERING

2097 BELSFORD DRIVE
 NOLENSVILLE, TN 37135
 JASON@MORELOCKENG.COM - (615) 300-6486

811
 Know what's below.
 Call before you dig.

SCALE: 1" = 20'

SURVEY INFO
 PROVIDED BY: M2 GROUP, LLC
 DATUM: TENNESSEE STATE PLANE (NAD83 & NAVD88)

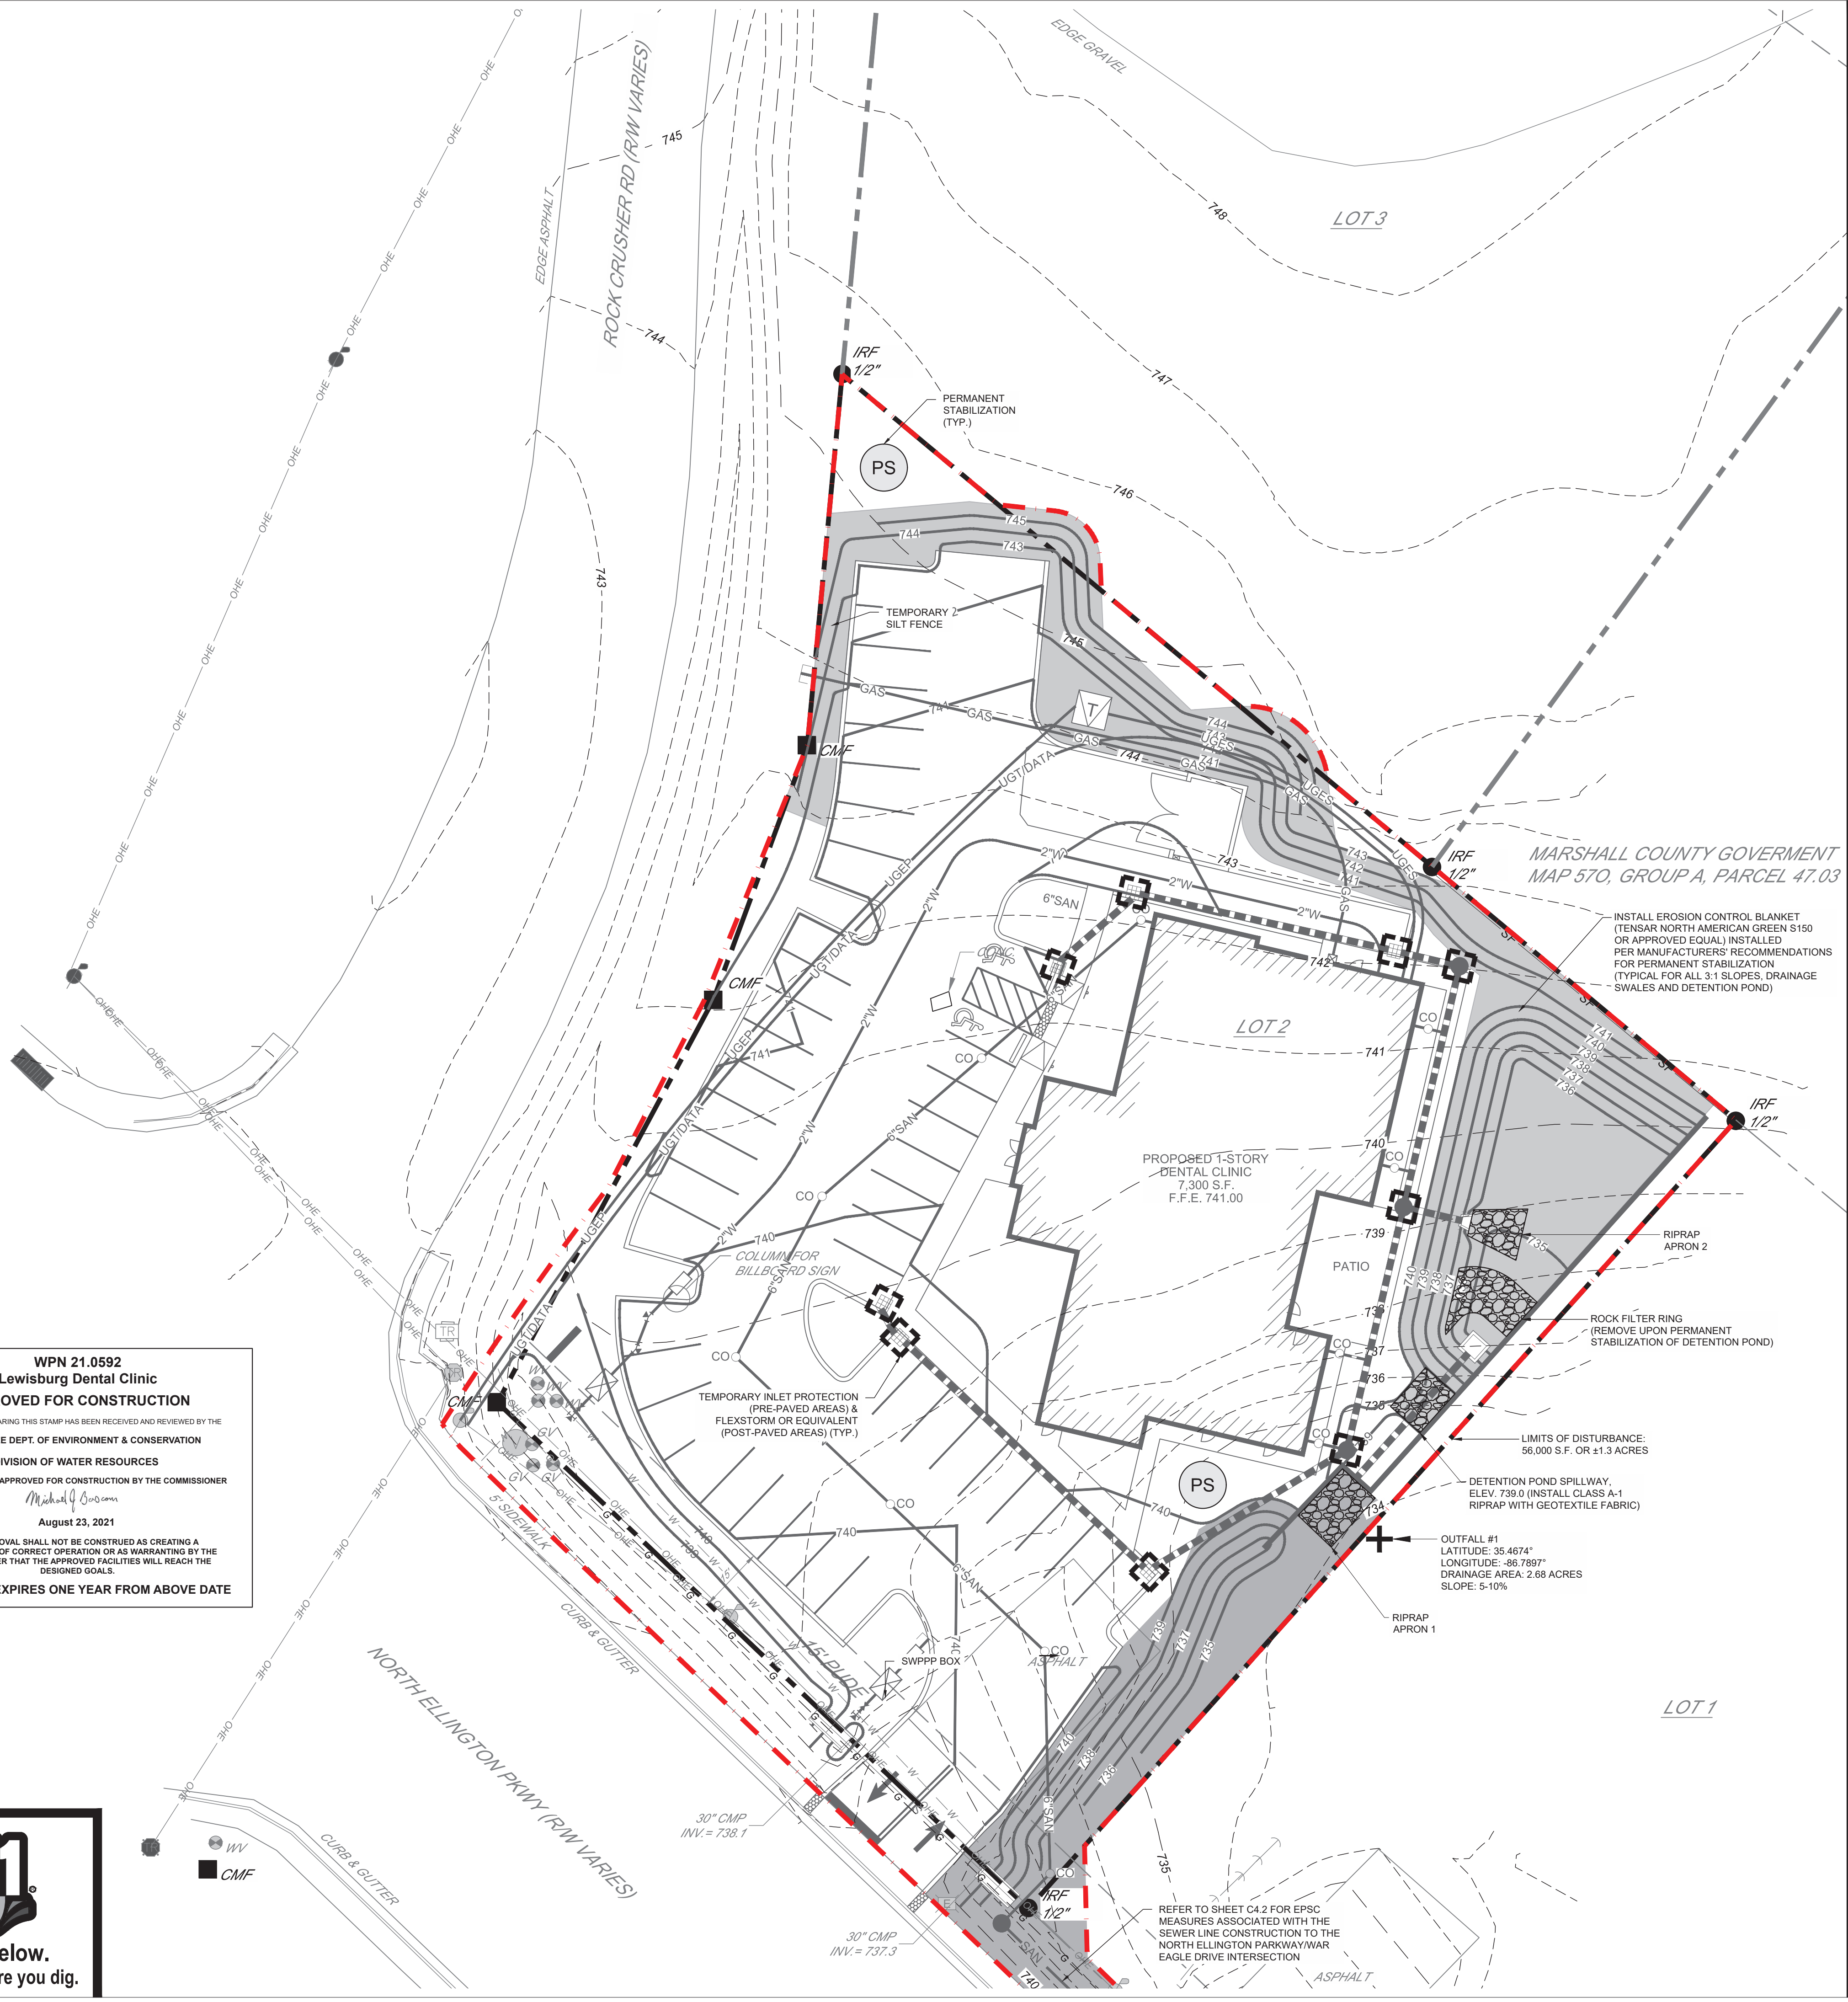H M H A
 H. Michael Hindman
 Architects, P.C.

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 Brentwood, Tennessee 37027
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JASON C. MORELOCK
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 No. 10890
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Dental Clinic
 1298 NORTH ELLINGTON PARKWAY
 TAX MAP 57 O, GROUP A, PARCEL 47.07, LEWISBURG, MARSHALL COUNTY, TN
SOUTHIE MAE, LLC
 1601 WESTGATE CIRCLE, BRENTWOOD, TENNESSEE 37027

Revisions

HMH Job Number
 20064


Drawn By
 JCM

Date
 07.02.21


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EPSC PLAN
 STAGE II



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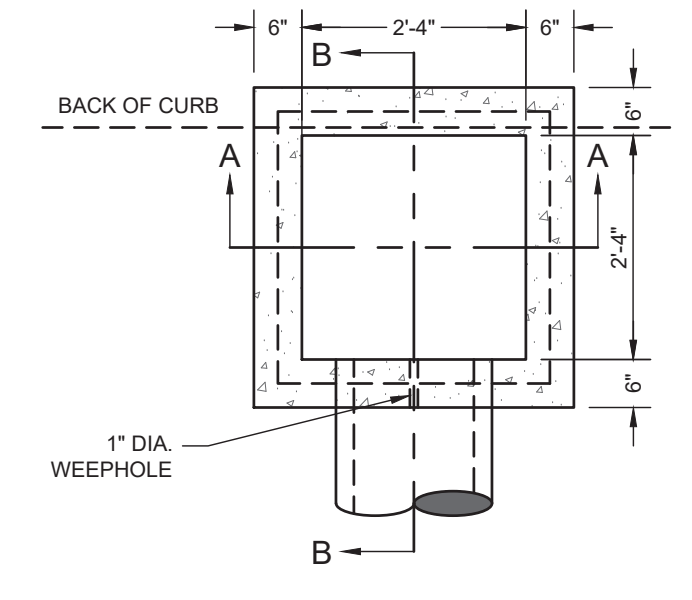
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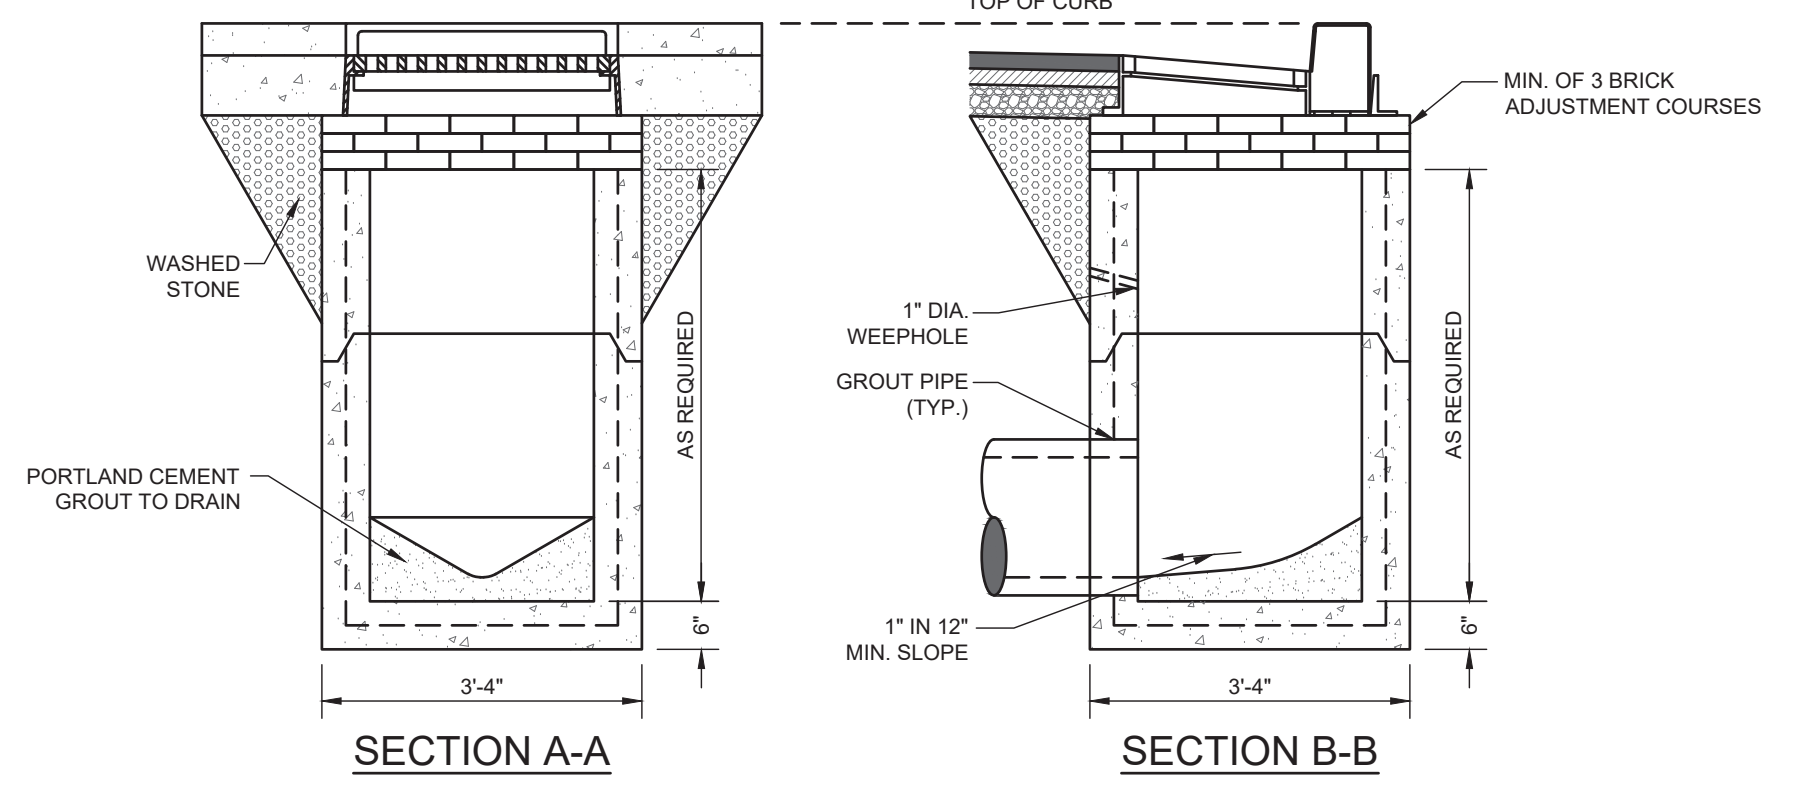
- NOTES:**
1. ALL MATERIAL, DESIGN, MANUFACTURING, PHYSICAL TEST REQUIREMENTS, FINISH MARKING, INSPECTION, REJECTION AND REPAIRS TO MEET / OR EXCEED SPECIFICATIONS FOR PRECAST-REINFORCED CONCRETE MANHOLE SECTIONS". PER ASTM C-478 (LATEST REVISION).
 2. MANHOLE SECTIONS TO BE TONGUE AND GROOVED.
 3. BENCHES MUST BE PROVIDED IN ALL STORM MANHOLES.
 4. USE JOHN BOUCHARD & SON'S CO. 1150, OR APPROVED EQUAL.
 5. CASTINGS SHALL BE FURNISHED WITH MANUFACTURERS' STANDARD ASPHALT COATING.
 6. GRATE AND STRUCTURE MUST MEET HEAVY DUTY TRAFFIC RATING (H20).
 7. CONCRETE = MIN. 4000 PSI AT 28 DAYS.
 8. REINFORCEMENT = MIN. 0.14 SQ. IN./SQ. FT., GRADE 60 STEEL.
 9. VERTICAL MANHOLE STEPS SHALL BE CONSISTENTLY SPACED AND SHALL COMPLY WITH OSHA (SUBPART D) "FIXED LADDERS" (SECTION 1910-27) AND/OR ASTM C-478.
 10. INSTALL LADDER BAR @ 16" O.C. FRAME AND GRATE SHALL BE STAMPED WITH "NO DUMPING...DRAINS TO RIVER" OR CITY/COUNTY APPROVED EQUAL.

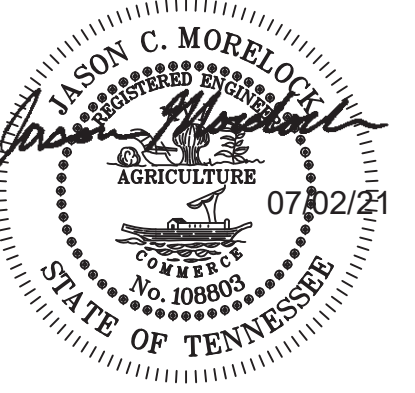

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ADJUST DIMENSIONS OF STRUCTURE AS NEEDED TO ACCOMMODATE PIPE SIZES AND ORIENTATION
 JOHN BOUCHARD & SON'S CO.
 1024 HARRISON STREET
 NASHVILLE, TN 37203
 615-256-0112 (PHONE)
 615-327-2427 (FAX)

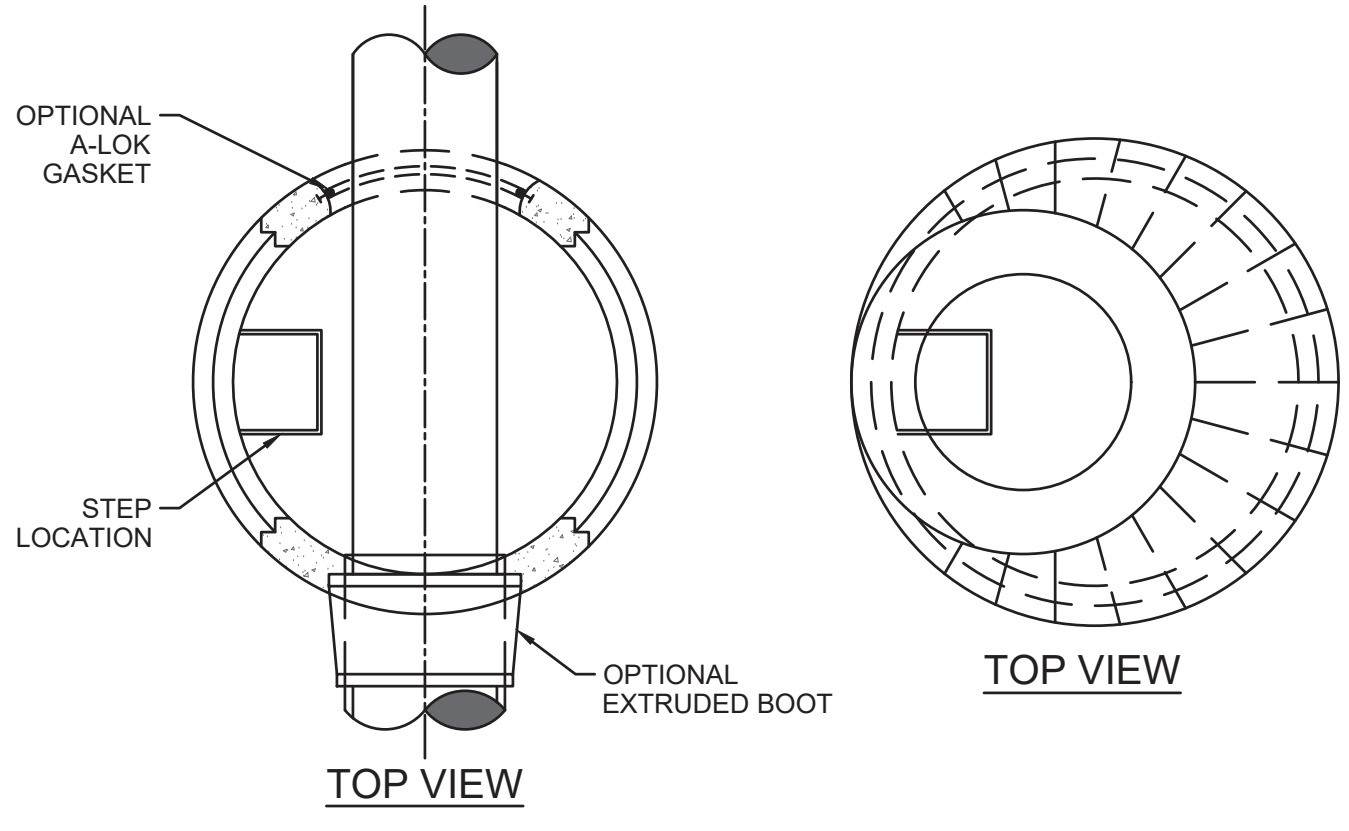

SINGLE CURB INLET
NOT TO SCALE

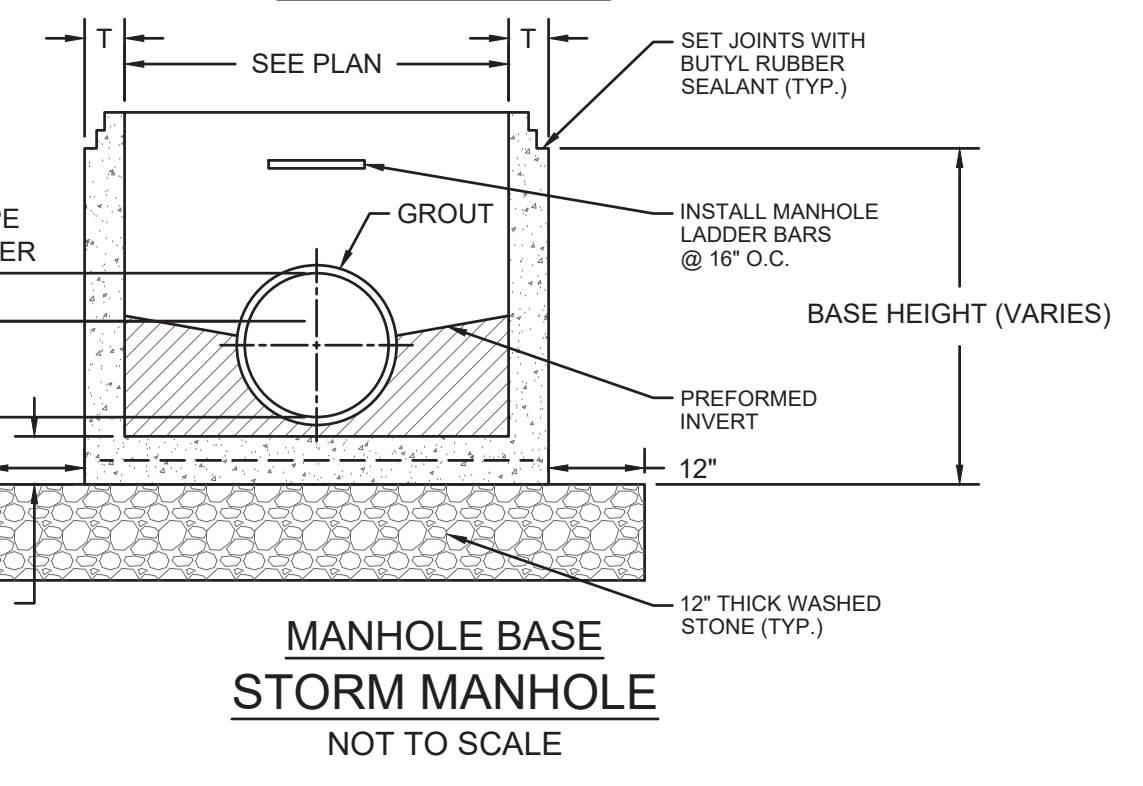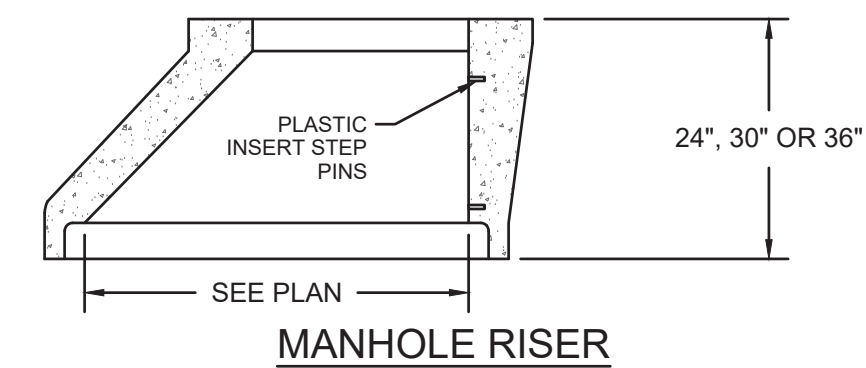
NOTES:

1. CASTING FOR STANDARD CURB AND GUTTER SHOWN. USE JOHN BOUCHARD & SON'S CO. 3103 & 3103-V FOR ROLLOVER CURB AND GUTTER OR APPROVED EQUAL. REFER TO STORM DRAINAGE SCHEDULES FOR CORRECT CASTING TYPE.
2. FRAME AND GRATE SHALL BE REQUIRED TO BE MARKED WITH "NO DUMPING...DRAINS TO RIVER" OR CITY/COUNTY APPROVED EQUAL.
3. CASTINGS SHALL BE FURNISHED WITH MANUFACTURERS' STANDARD ASPHALT COATING.
4. GRATE AND STRUCTURE MUST MEET HEAVY DUTY TRAFFIC RATING (H20).
5. CONCRETE = MIN. 4000 PSI AT 28 DAYS
6. REINFORCEMENT = MIN. 0.14 SQ. IN./SQ. FT., GRADE 60 STEEL
7. PRECAST CIRCULAR MANHOLE SECTIONS MAY BE PROVIDED IN LIEU OF SQUARE OR RECTANGULAR BOXES. SUBSTITUTIONS AFTER BID AT NO ADDITIONAL COST TO OWNER. ANY COST SAVINGS SHALL BE CREDITED TO THE OWNER.
8. SINGLE INLET SHALL BE PROVIDED WITH ONE (1) 1" Ø WEEP HOLE ON THE SIDE FACING THE ASPHALT OR CONCRETE PAVEMENT.
9. INSTALL MANHOLE STEPS 2146 TYPE TWO, GRADE 49108 @ 16" O.C.
10. ADJUST ALL SIDES OF THE FRAME AND GRATE TO MATCH ROADWAY CROSS SLOPE AND LONGITUDINAL SLOPE.


NOTES:

1. PIPE BEDDING: TDOT CLASS B BEDDING COMPACTED TO 95% OF THE MAXIMUM DENSITY AS PER AASHTO T-180.
2. TRENCH BACKFILL: TDOT CLASS B OR CLASS C MATERIAL COMPACTED TO 95% OF THE MAXIMUM DENSITY AS PER AASHTO T-180.
3. TRENCH BACKFILL UTILIZING SELECT COMMON FILL SHALL BE IN ACCORDANCE WITH TDOT SPECIFICATIONS.
4. (*) 15" MAX. FOR PIPE DIAMETER LESS THAN 24", AND 24" MAX. FOR PIPE DIAMETER 24" AND LARGER.
5. WATER SHALL NOT BE PERMITTED IN THE TRENCH DURING CONSTRUCTION.
6. ALL PIPE TO BE INSTALLED WITH BELL FACING UPSTREAM TO THE DIRECTION OF THE FLOW.
7. SHEETING AND BRACING SHALL BE USED IN ACCORDANCE WITH CURRENT TRENCHING REGULATIONS AND WHERE UNSAFE CONDITIONS EXIST.
8. FINAL RESTORATION IN IMPROVED AREAS SHALL BE IN COMPLIANCE WITH CITY OR TENNESSEE DEPARTMENT OF TRANSPORTATION SPECIFICATIONS.

SIEVE ANALYSIS CHART					
CRUSHED STONE ASTM D-48, NUMBER 67		SAND		SELECT NATIVE MATERIAL	
NOMINAL SIZE	% PASSING	NOMINAL SIZE	% PASSING	NOMINAL SIZE	% PASSING
1"	100	1"	100	1"	100
3/4"	90 - 100	#4	60 - 100	#4	40 - 100
3/8"	20 - 55	#200	0 - 5	#200	0 - 50
#4	0 - 10	MAXIMUM P.I. = 5			
#8	0 - 5	MAXIMUM L.L. = 30		MAXIMUM P.I. = 12	

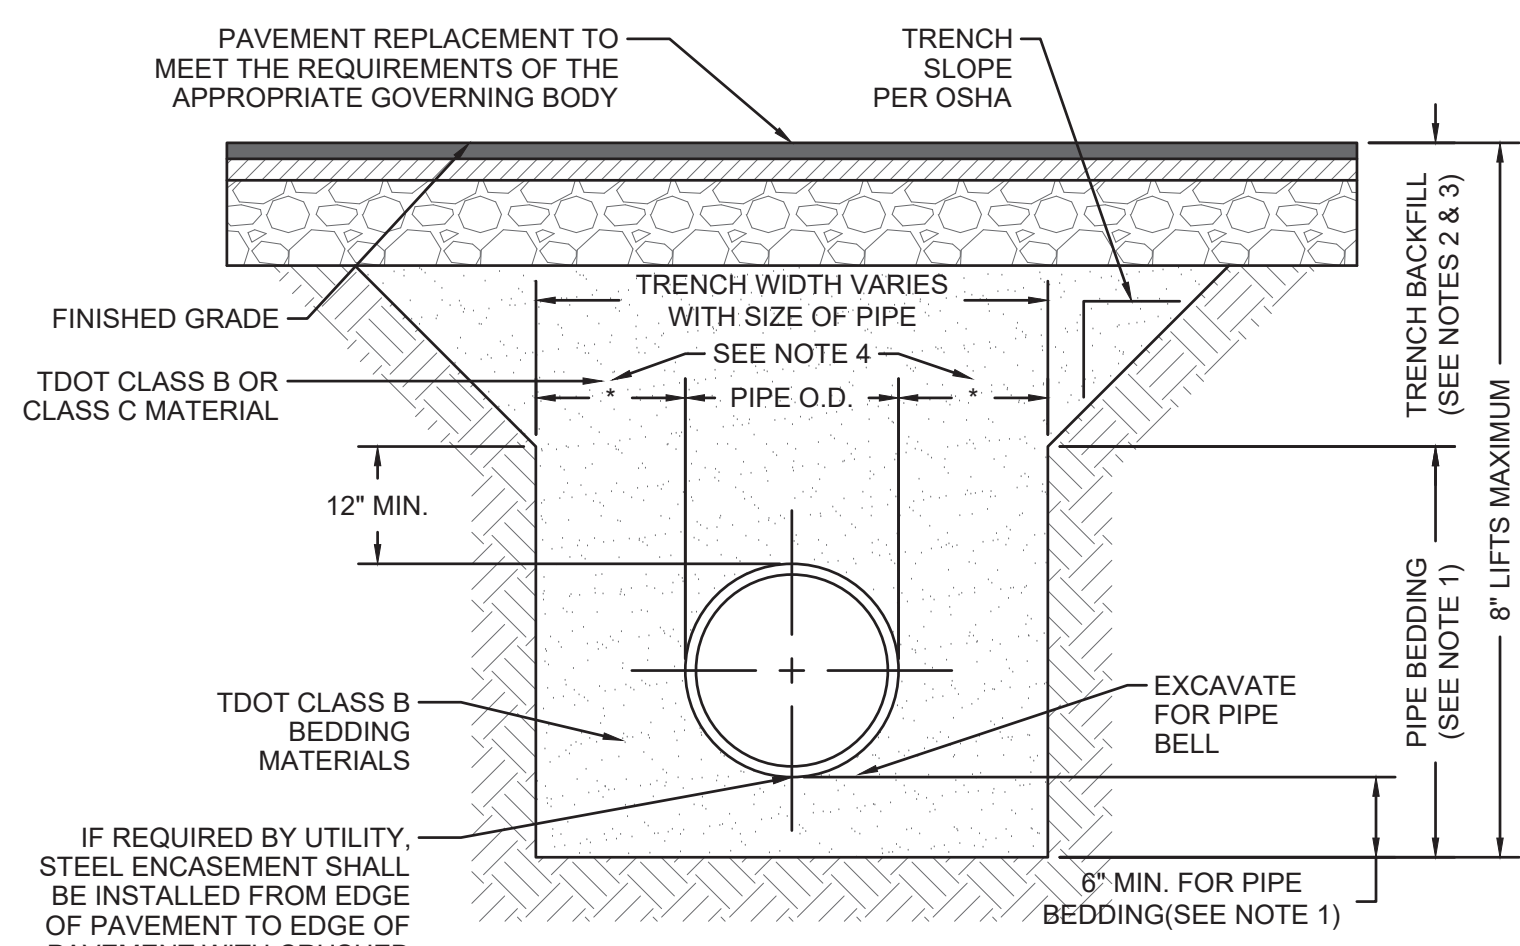


PAVED AREAS

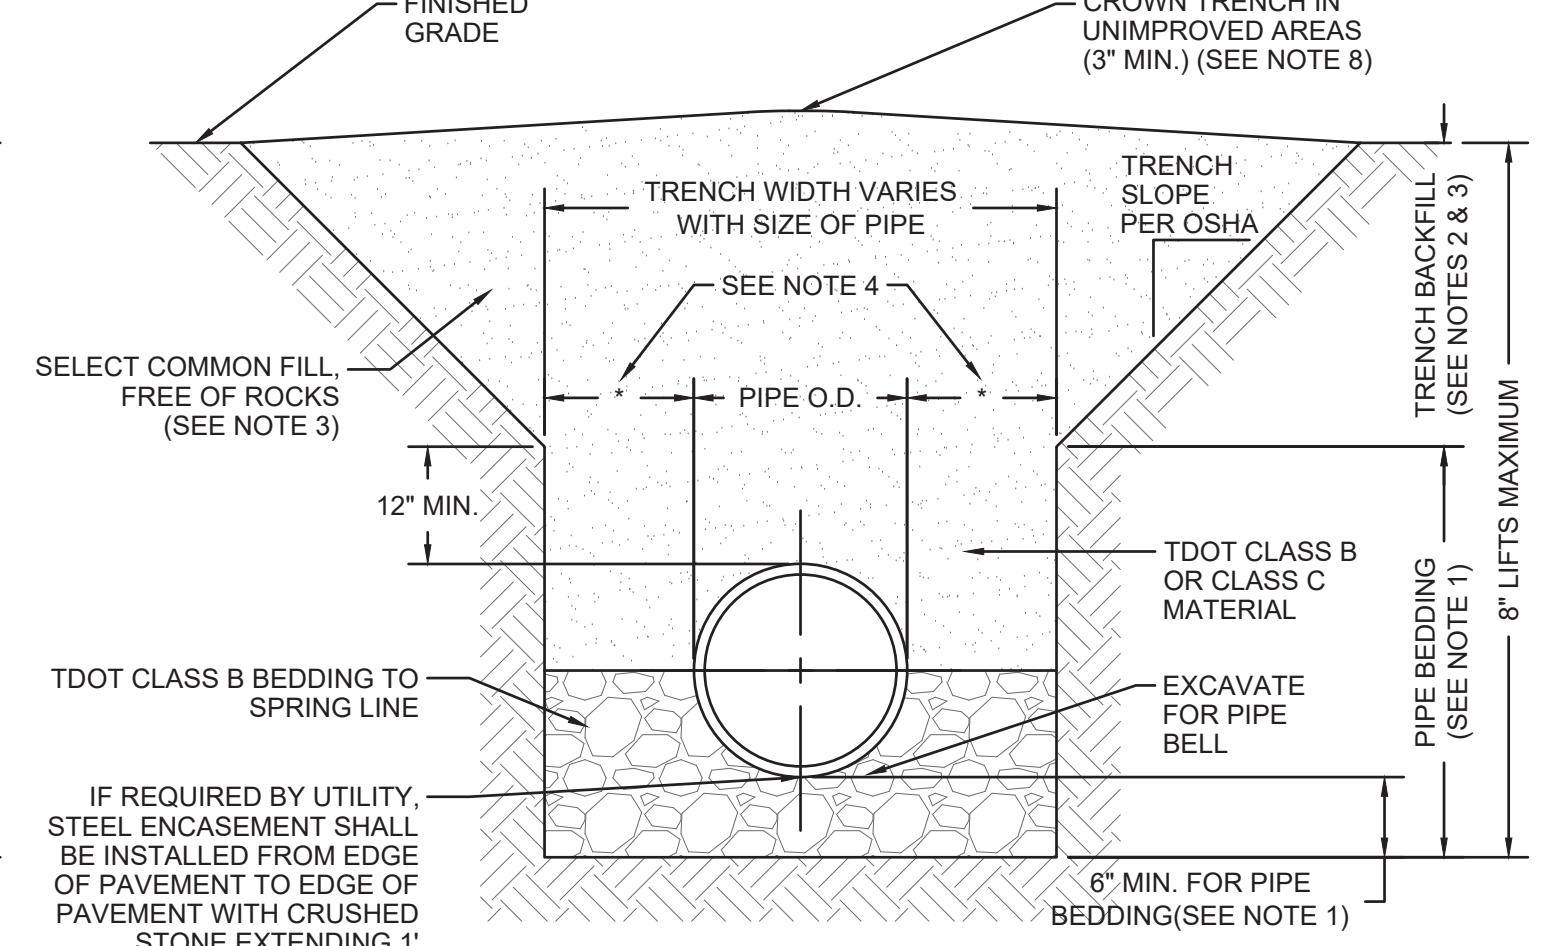

NON-PAVED AREAS

TYPICAL STORM BEDDING
NOT TO SCALE

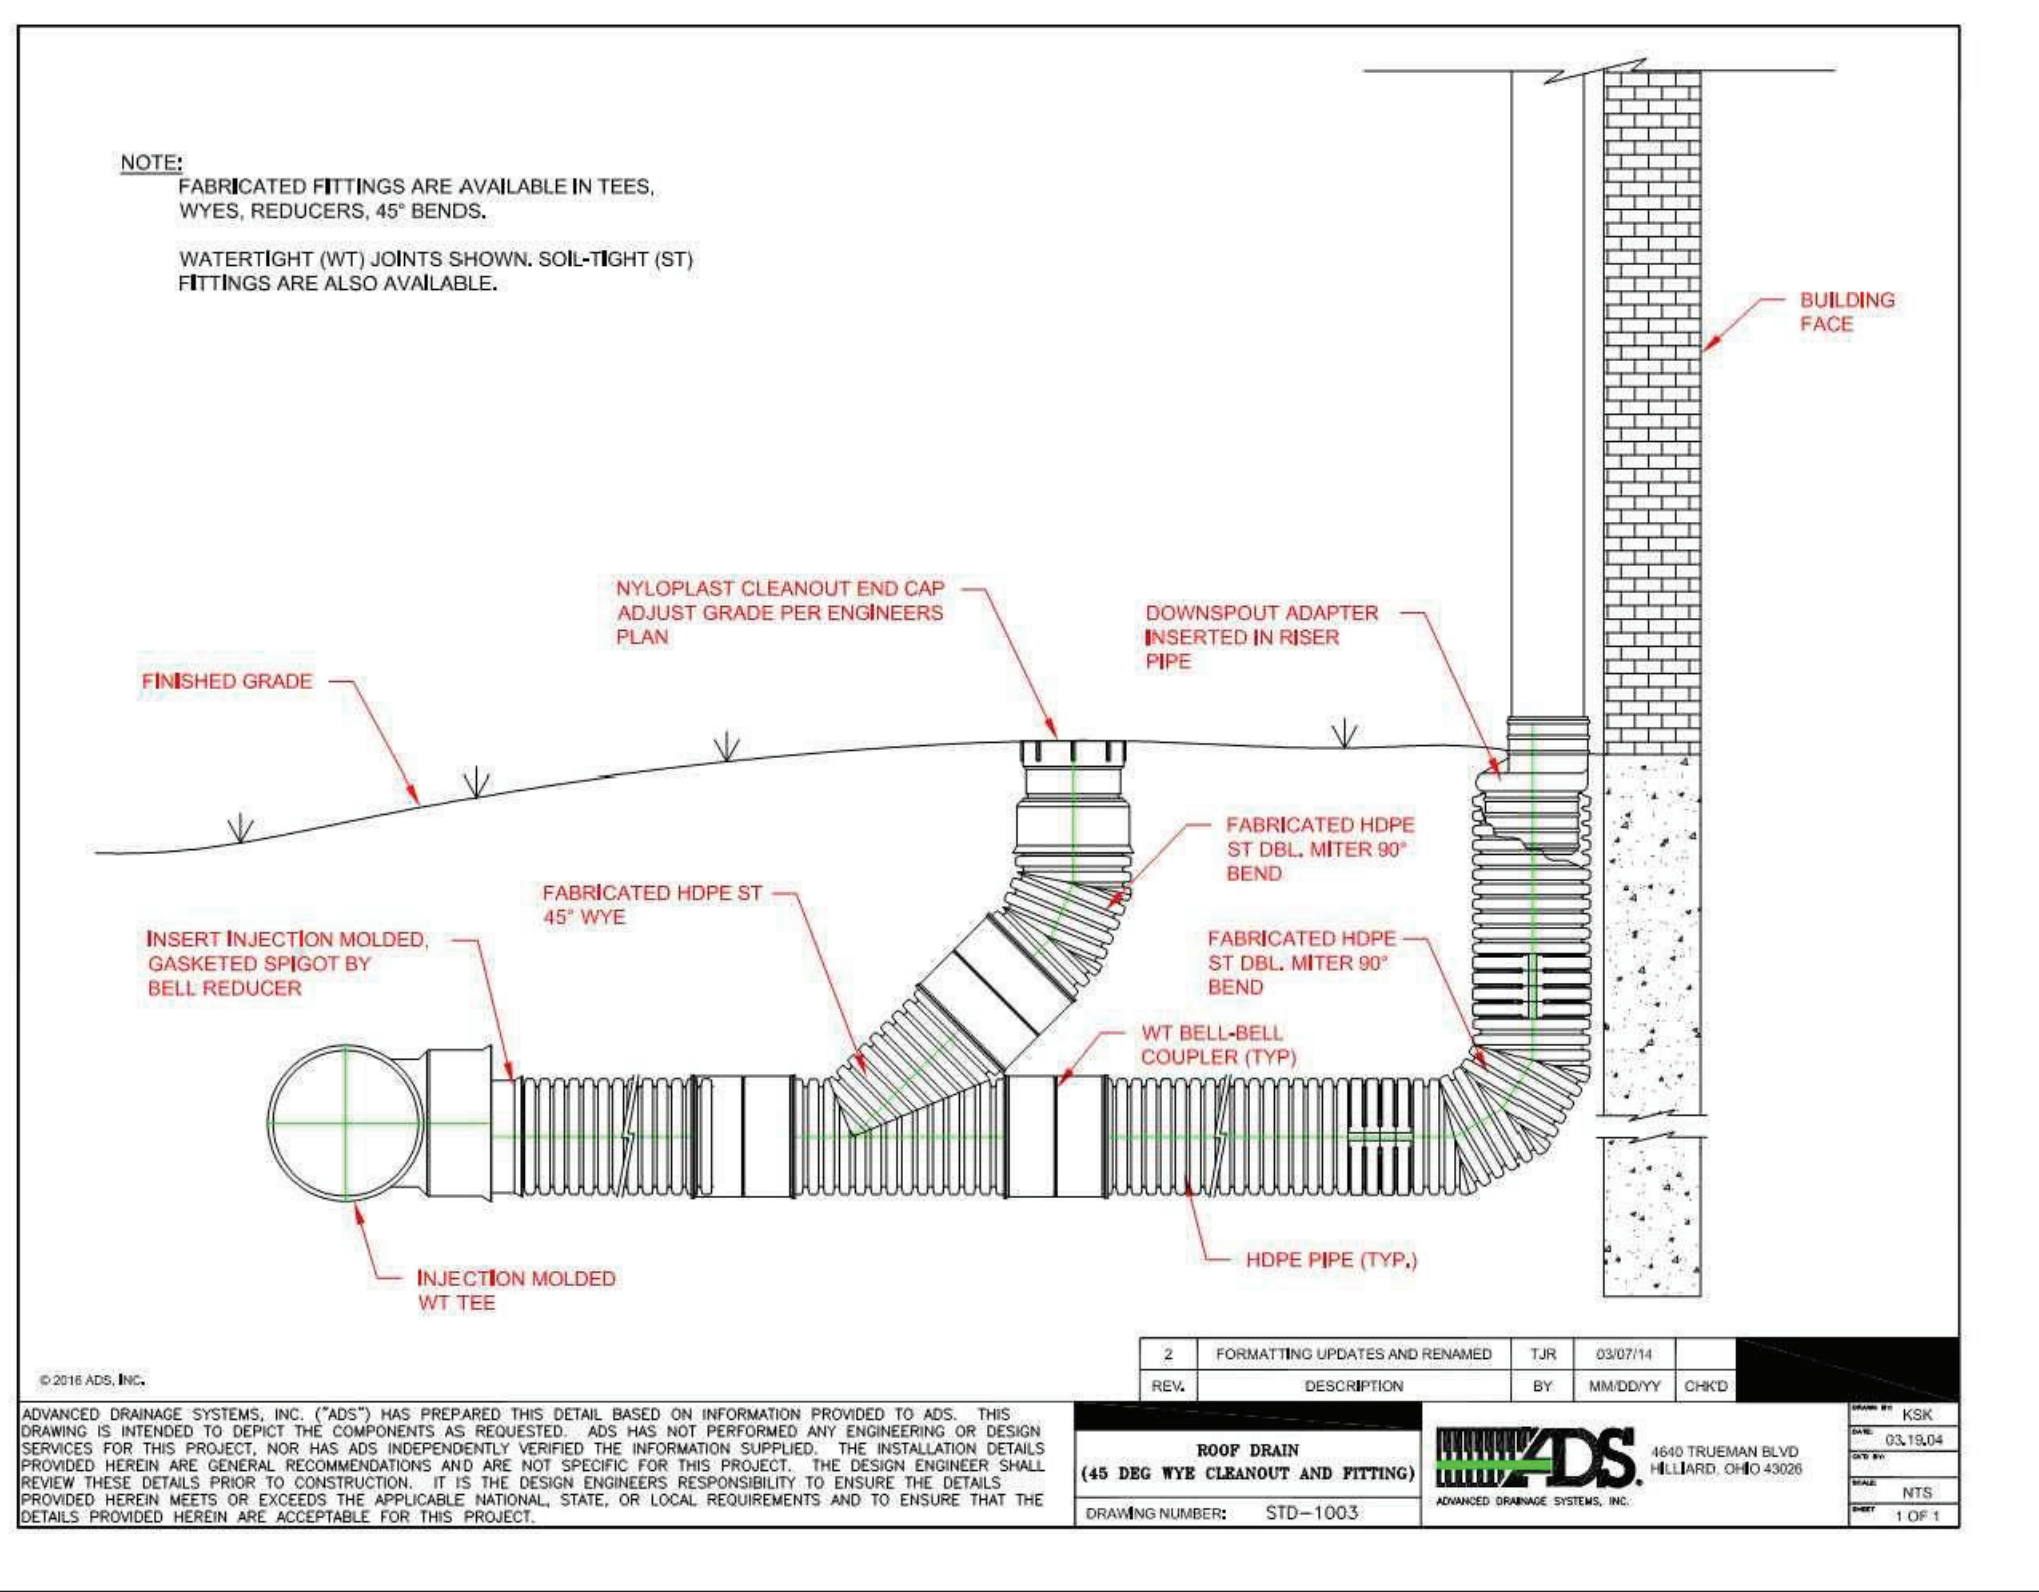

STORM CLEANOUT
NOT TO SCALE





2097 BELSFORD DRIVE
 NOLENSVILLE, TN 37135
 JASON@MORELOCKENG.COM - (615) 300-6486

GRADING, DRAINAGE
 & EPSC DETAILS
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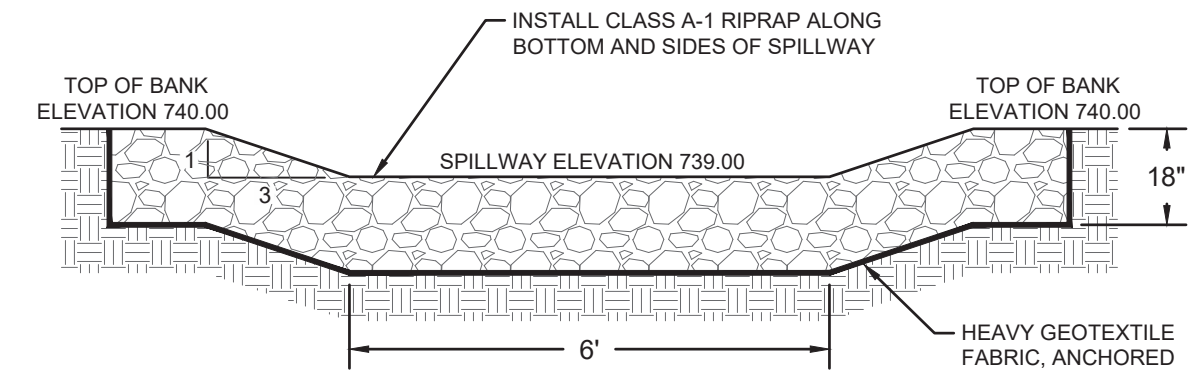
Revisions
 HMH Job Number
 20064
 Drawn By
 JCM
 Date
 07.02.21
 Drawing

NOTES:

- ALL CONCRETE SHALL BE CLASS A CONCRETE, 4000 PSI, 5% AIR ENTRAINED.
- INLET JOINTS TO BE SEALED WITH 1" DIAMETER FLEXIBLE BUTYL RUBBER JOINT SEALANT, USE 1/2" DIAMETER FOR FRAME AND GRATE.
- LIFTING HOLES TO BE POINTED WITH NON-SHRINK GROUT, AND LEFT WATERTIGHT, NEAT AND SMOOTH.
- COAT WITH BITUMINOUS PAINT OR ASPHALT COATING.
- CONTRACTOR SHALL REFER TO DETENTION POND BERM WITH OUTLET STRUCTURE DETAIL ON THIS SHEET FOR DETAILS OF DETENTION POND BERM.
- CONTRACTOR SHALL REFER TO DETENTION POND OUTLET STRUCTURE TRASH RACK DETAIL, COMPACTION KEY DETAIL AND ANTI-SEEP COLLAR DETAIL FOR DETAILS OF THESE ITEMS ON THIS SHEET.

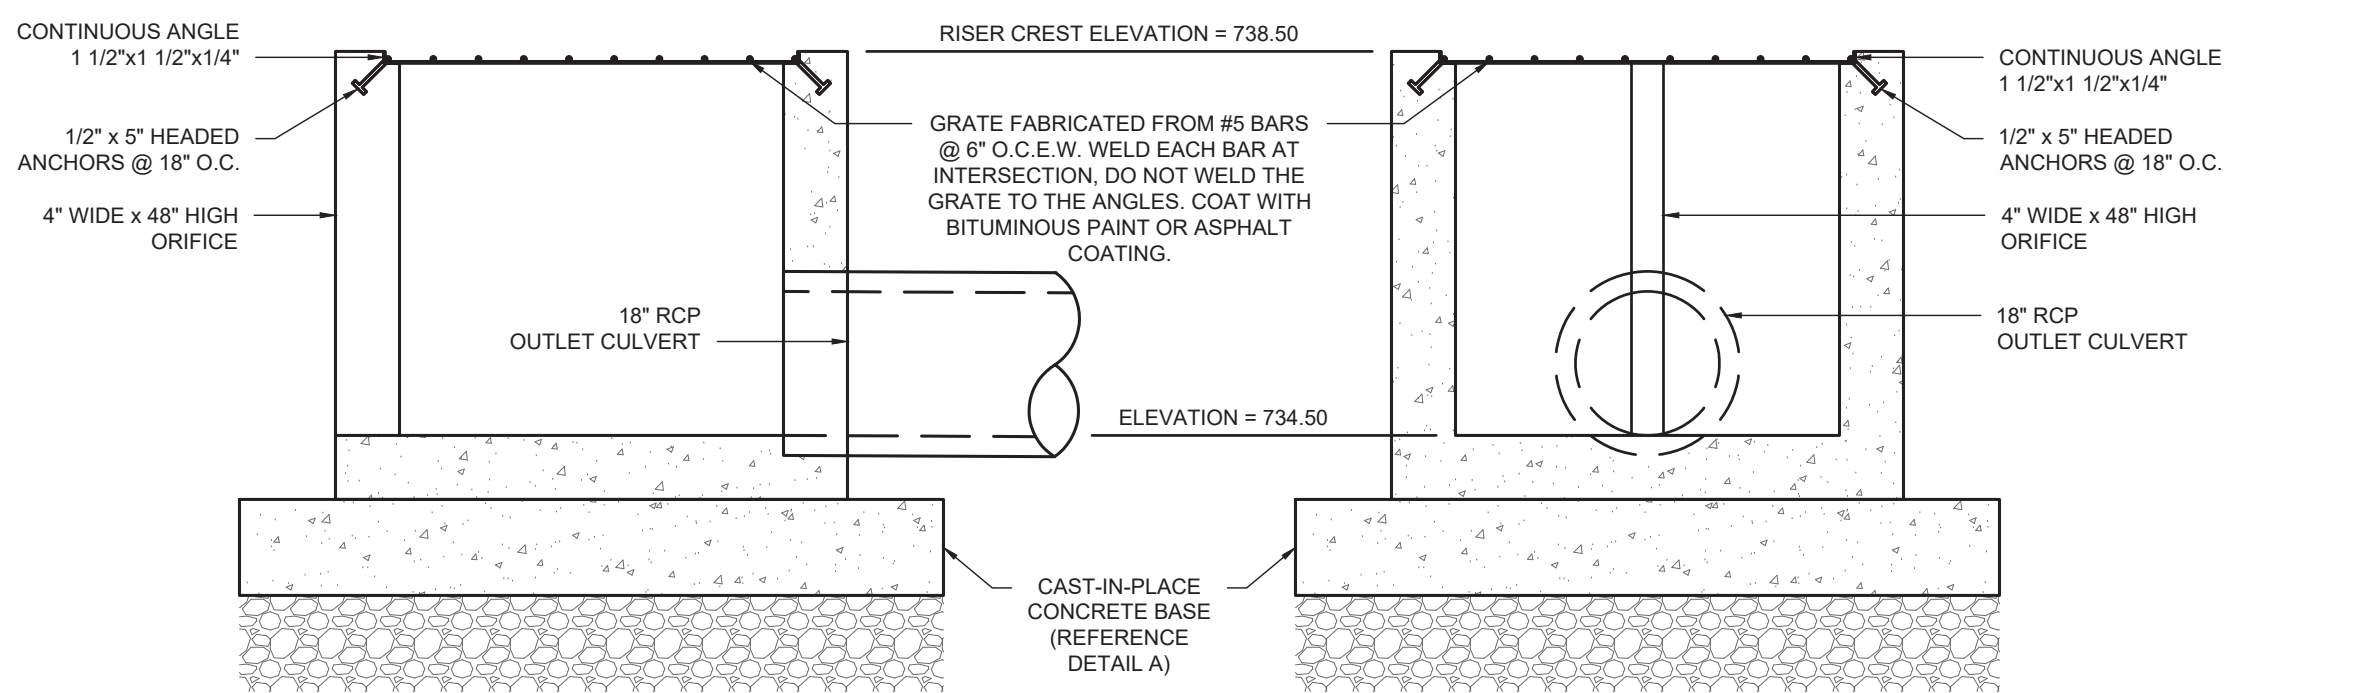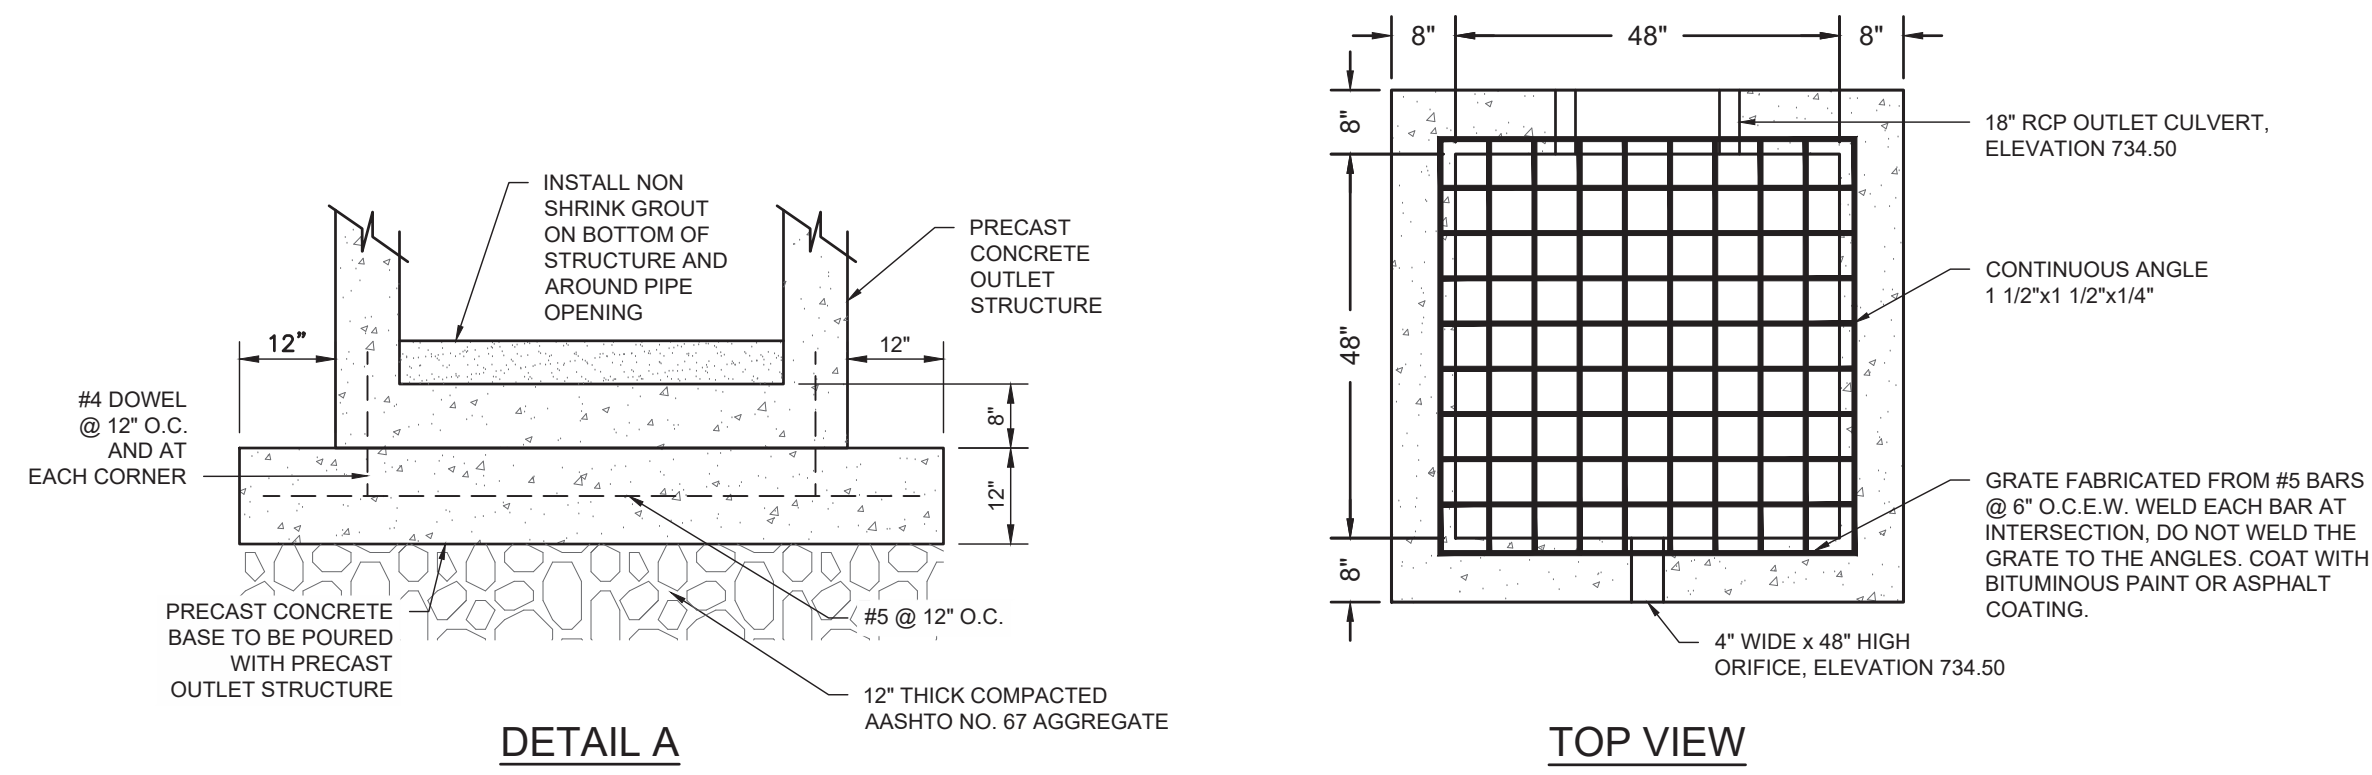


DETENTION POND OUTLET STRUCTURE
NOT TO SCALE




DETENTION POND SPILLWAY CROSS SECTION
NOT TO SCALE

NOTES:


- ALL FILL MATERIAL SHALL BE APPROVED BY THE GEOTECHNICAL ENGINEER AND COMPACTED TO 95% OF MAXIMUM DENSITY PER ASTM D-698 OR AS DIRECTED BY THE ON SITE GEOTECHNICAL ENGINEER.
- OVERBUILD ENTIRE BERM BY 5 FEET ON EITHER SIDE OF BERM DURING FILL PLACEMENT/COMPACTION AND REMOVE EXCESS MATERIAL TO MATCH TYPICAL CROSS SECTION WHEN CONSTRUCTED TO PROPER ELEVATION.
- BARREL PIPE SHALL BE FITTED WITH ANTI-SEEP COLLARS AS SHOWN ON DETAIL THIS SHEET.
- EXISTING GROUND (BEDROCK CONDITION) SHALL BE CLEANED OF ALL NATIVE SOILS/LOOSE MATERIAL AND FISHERS IN BEDROCK SHALL BE GROUTED FLUSH WITH SURFACE. CONSULT THE ON SITE GEOTECHNICAL ENGINEER FOR PROPER PREPARATION BEFORE APPROVED FILL IS PLACED.
- EXISTING GROUND CONDITION SHALL MEET THE REQUIREMENTS OF THE TYPICAL COMPACTION KEY DETAIL THIS SHEET. AN APPROVED EQUIVALENT KEY MAY BE UTILIZED TO PROVIDE MAXIMUM COHESION AS DIRECTED BY THE ON SITE GEOTECHNICAL ENGINEER.

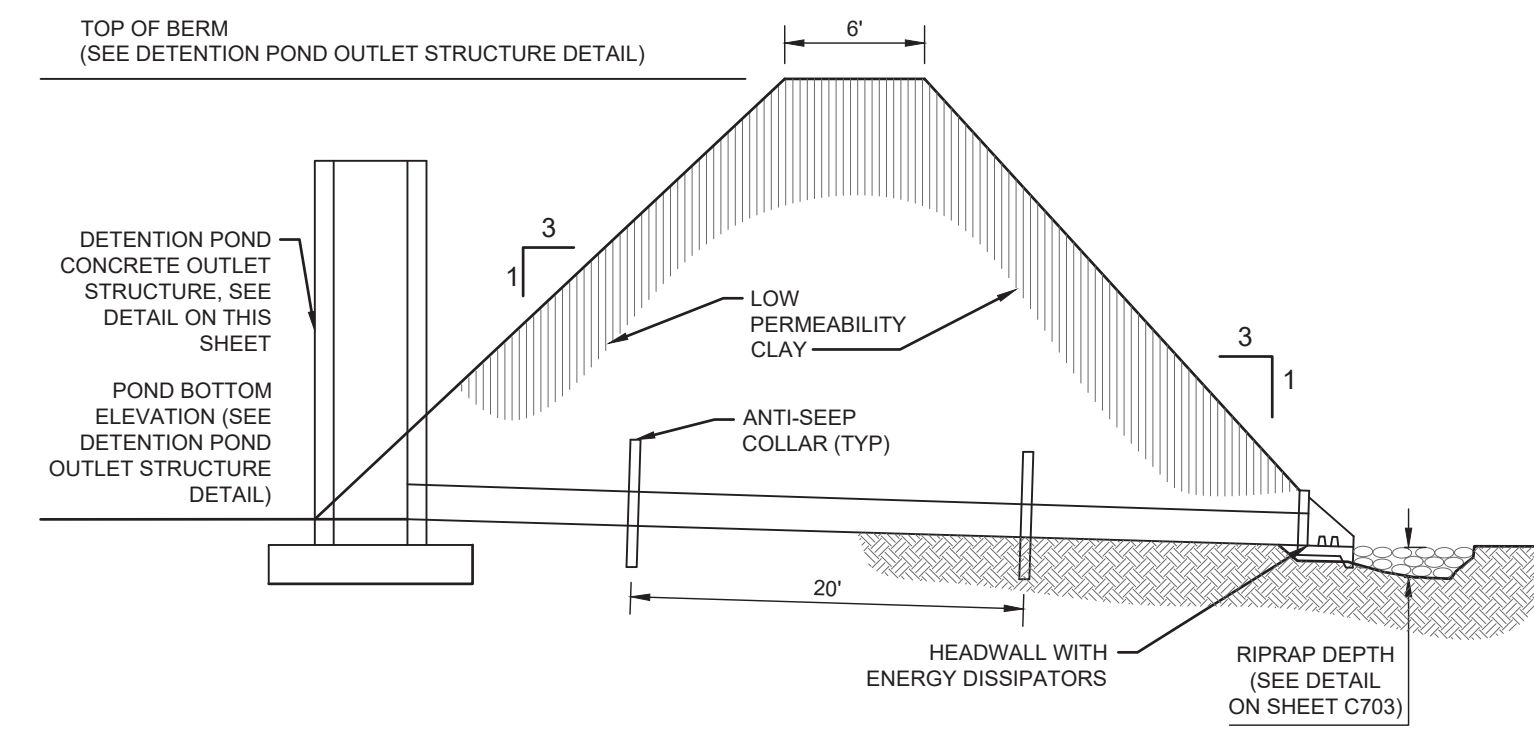


DETENTION POND BERM WITH OUTLET STRUCTURE
NOT TO SCALE

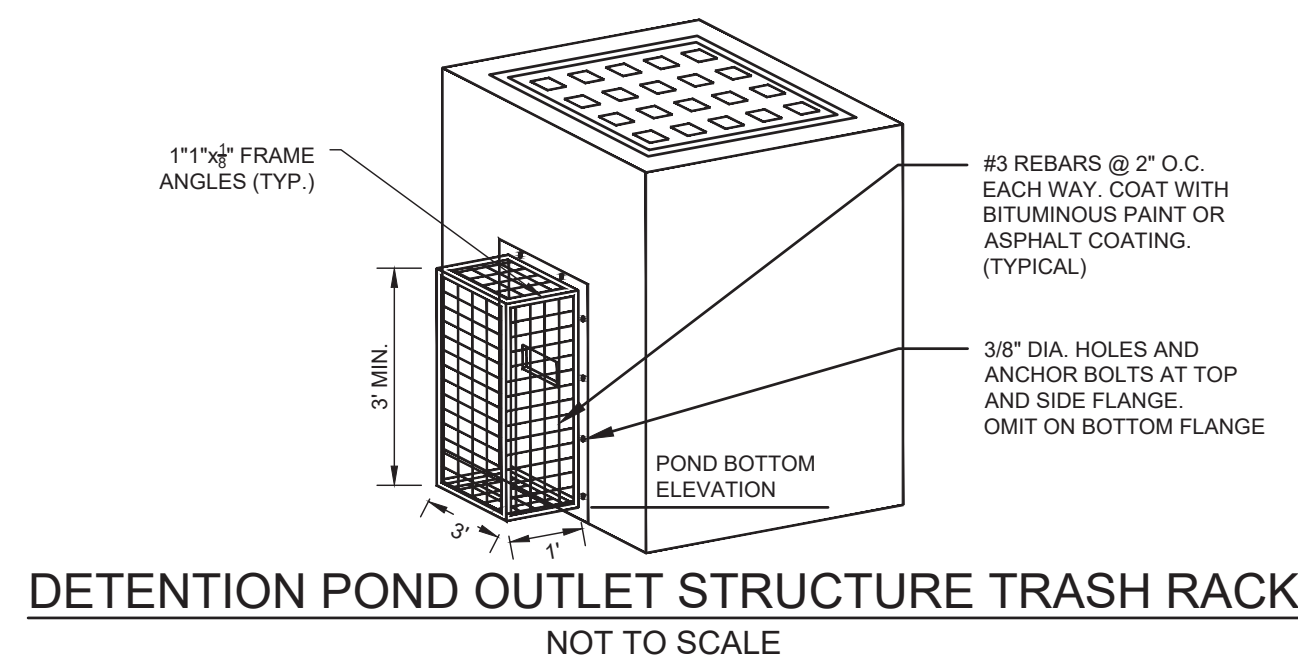

DETENTION POND OUTLET STRUCTURE TRASH RACK
NOT TO SCALE

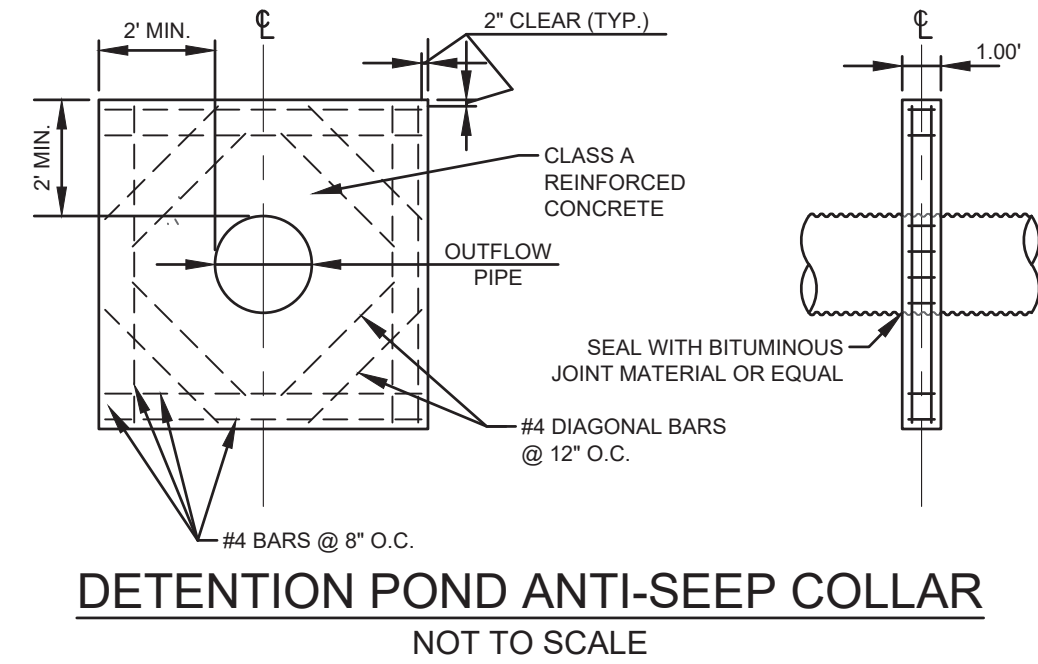


DETENTION POND ANTI-SEEP COLLAR
NOT TO SCALE

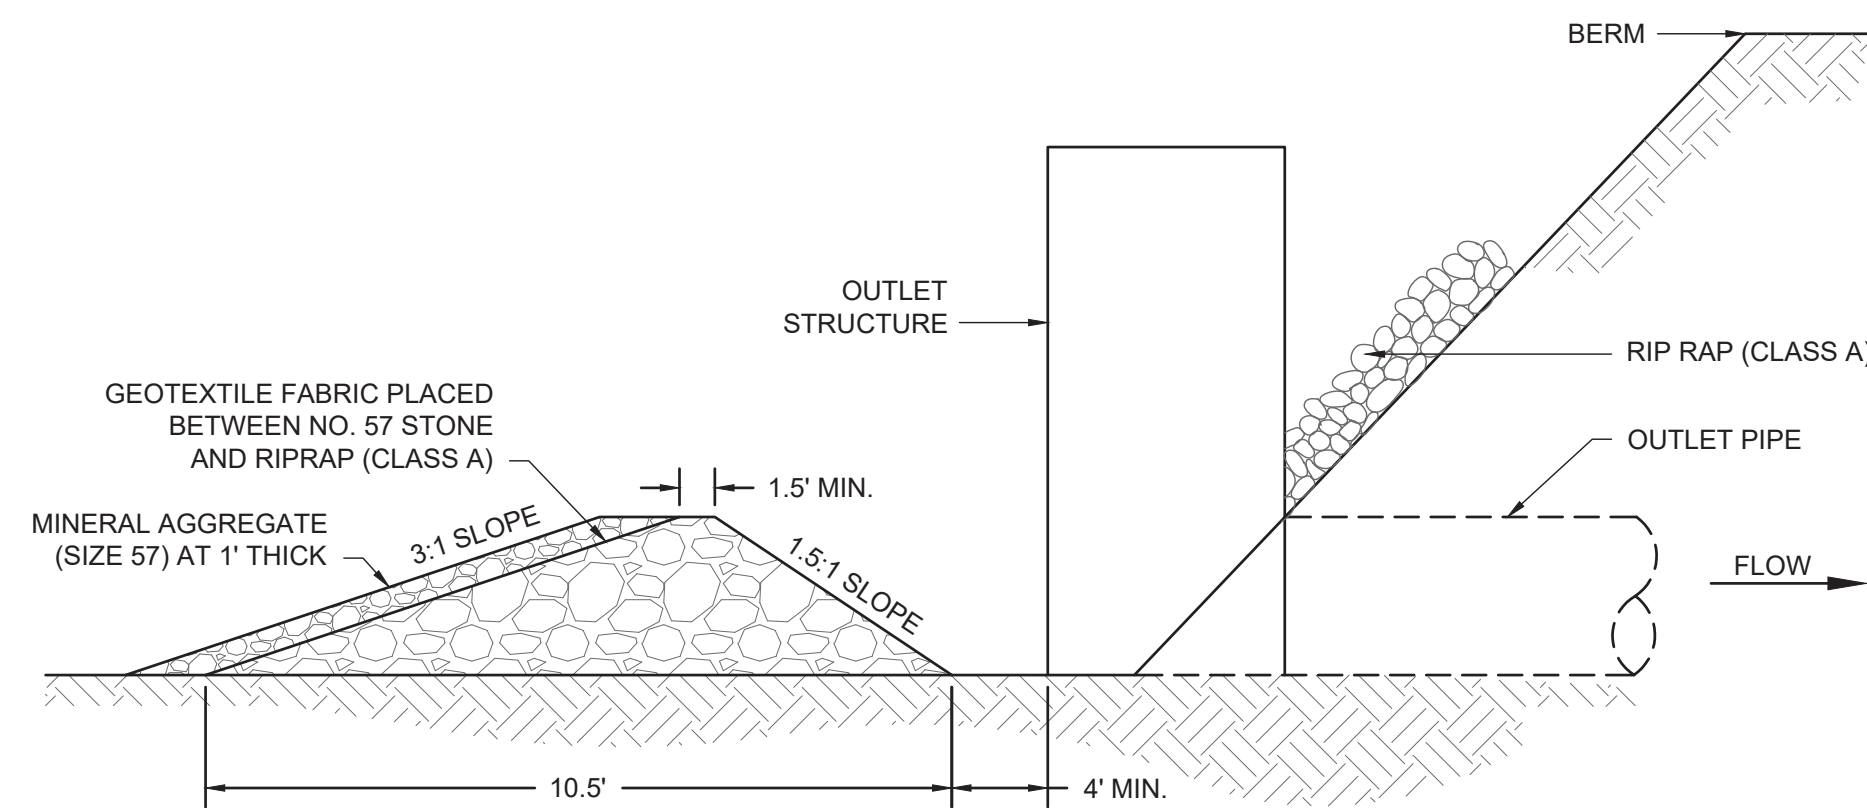

SECTIONAL VIEW
NOT TO SCALE

NOTE:
INSTALLATION AND MAINTENANCE SHALL MEET THE REQUIREMENTS OF THE TENNESSEE EROSION & SEDIMENT CONTROL HANDBOOK, TENNESSEE DEPARTMENT OF ENVIRONMENT AND CONSERVATION, LATEST EDITION.

ROCK FILTER RING
NOT TO SCALE

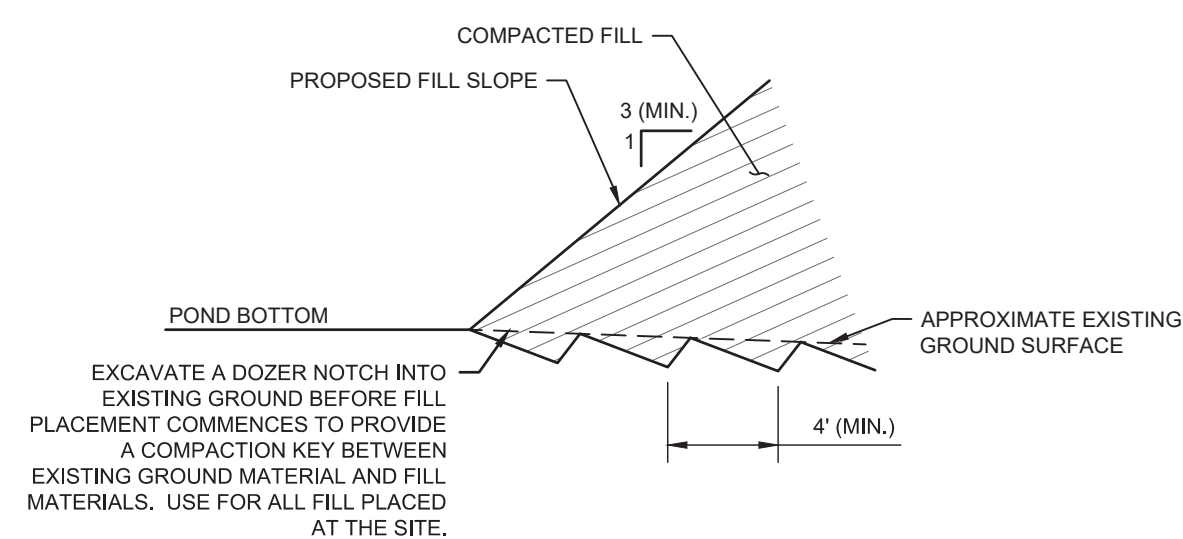

DETENTION POND COMPACTION KEY
NOT TO SCALE

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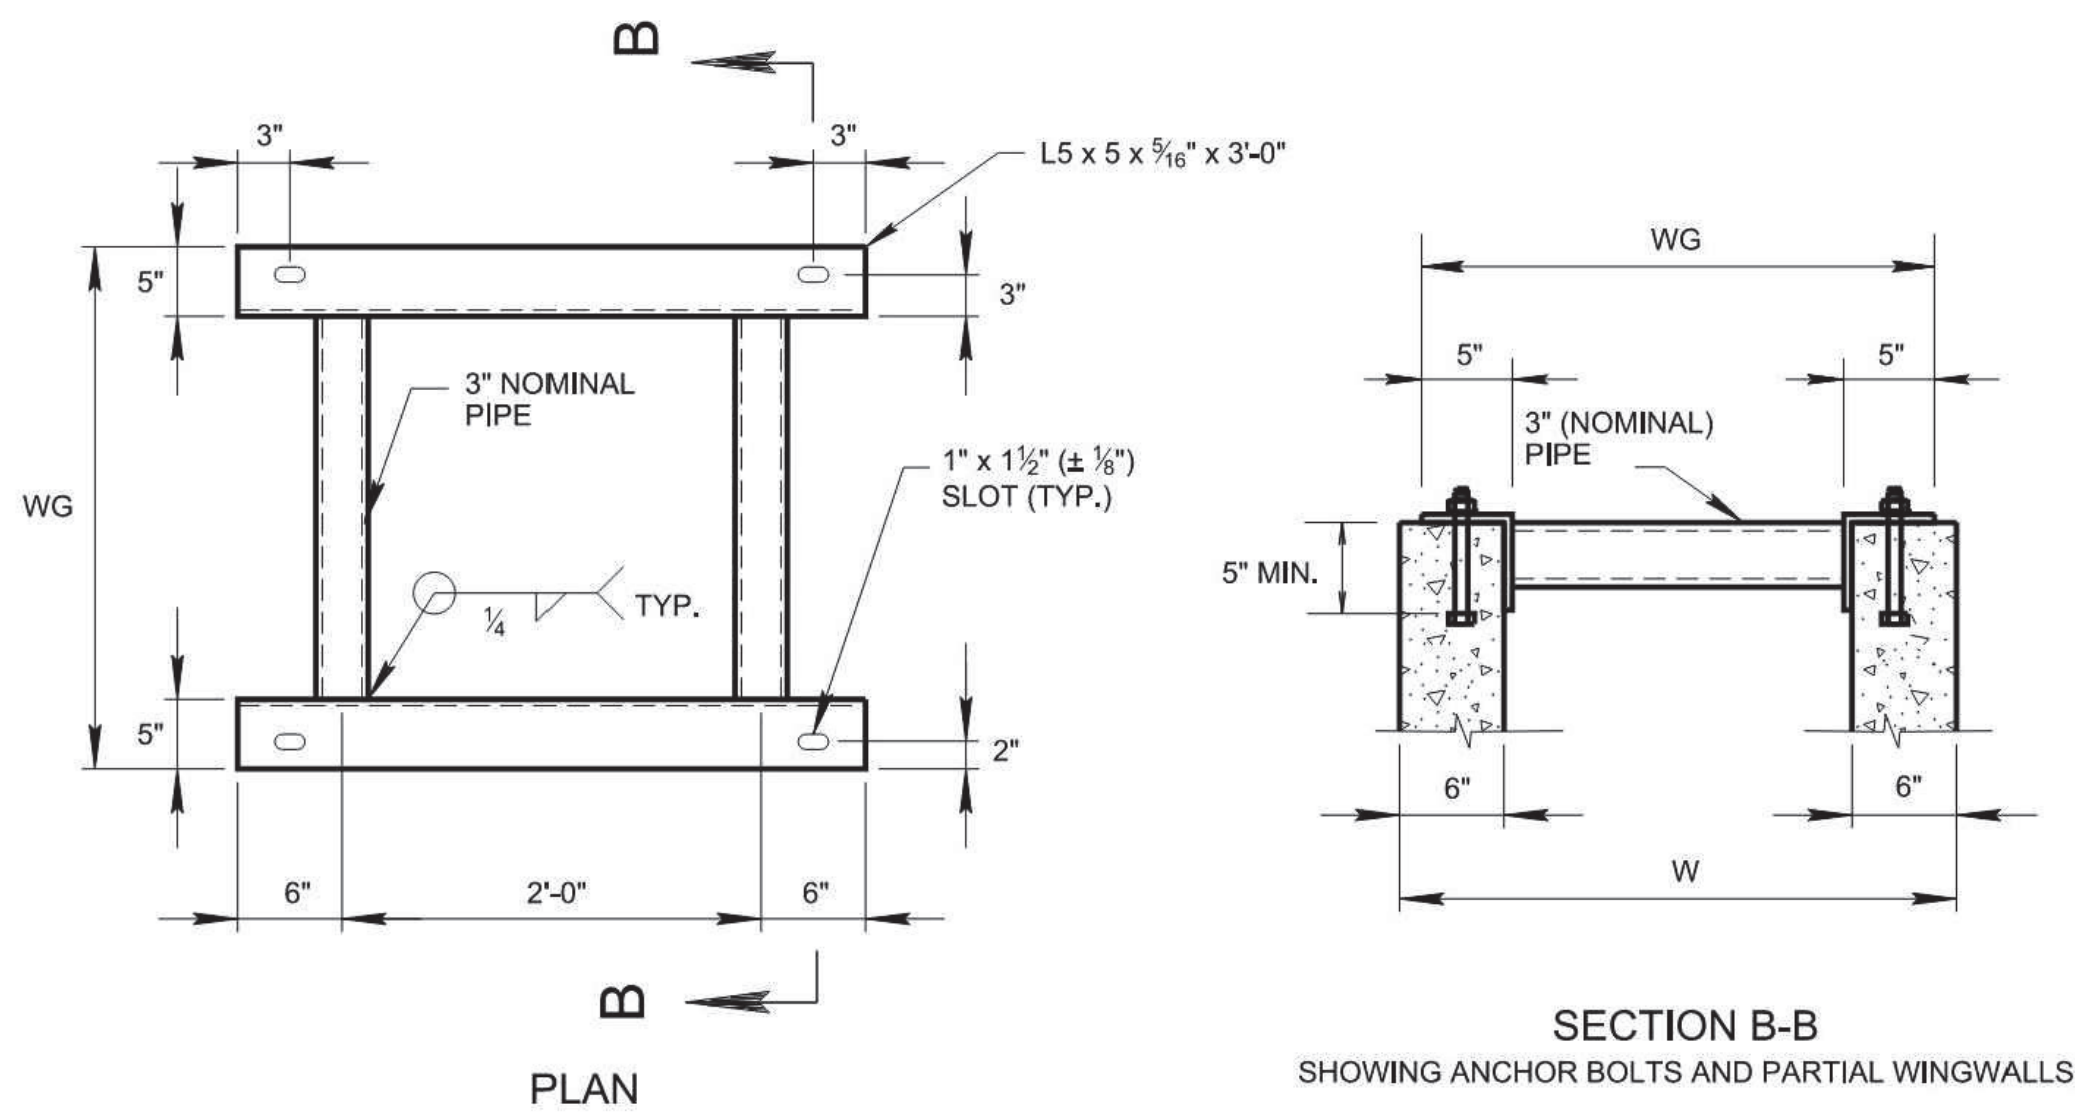
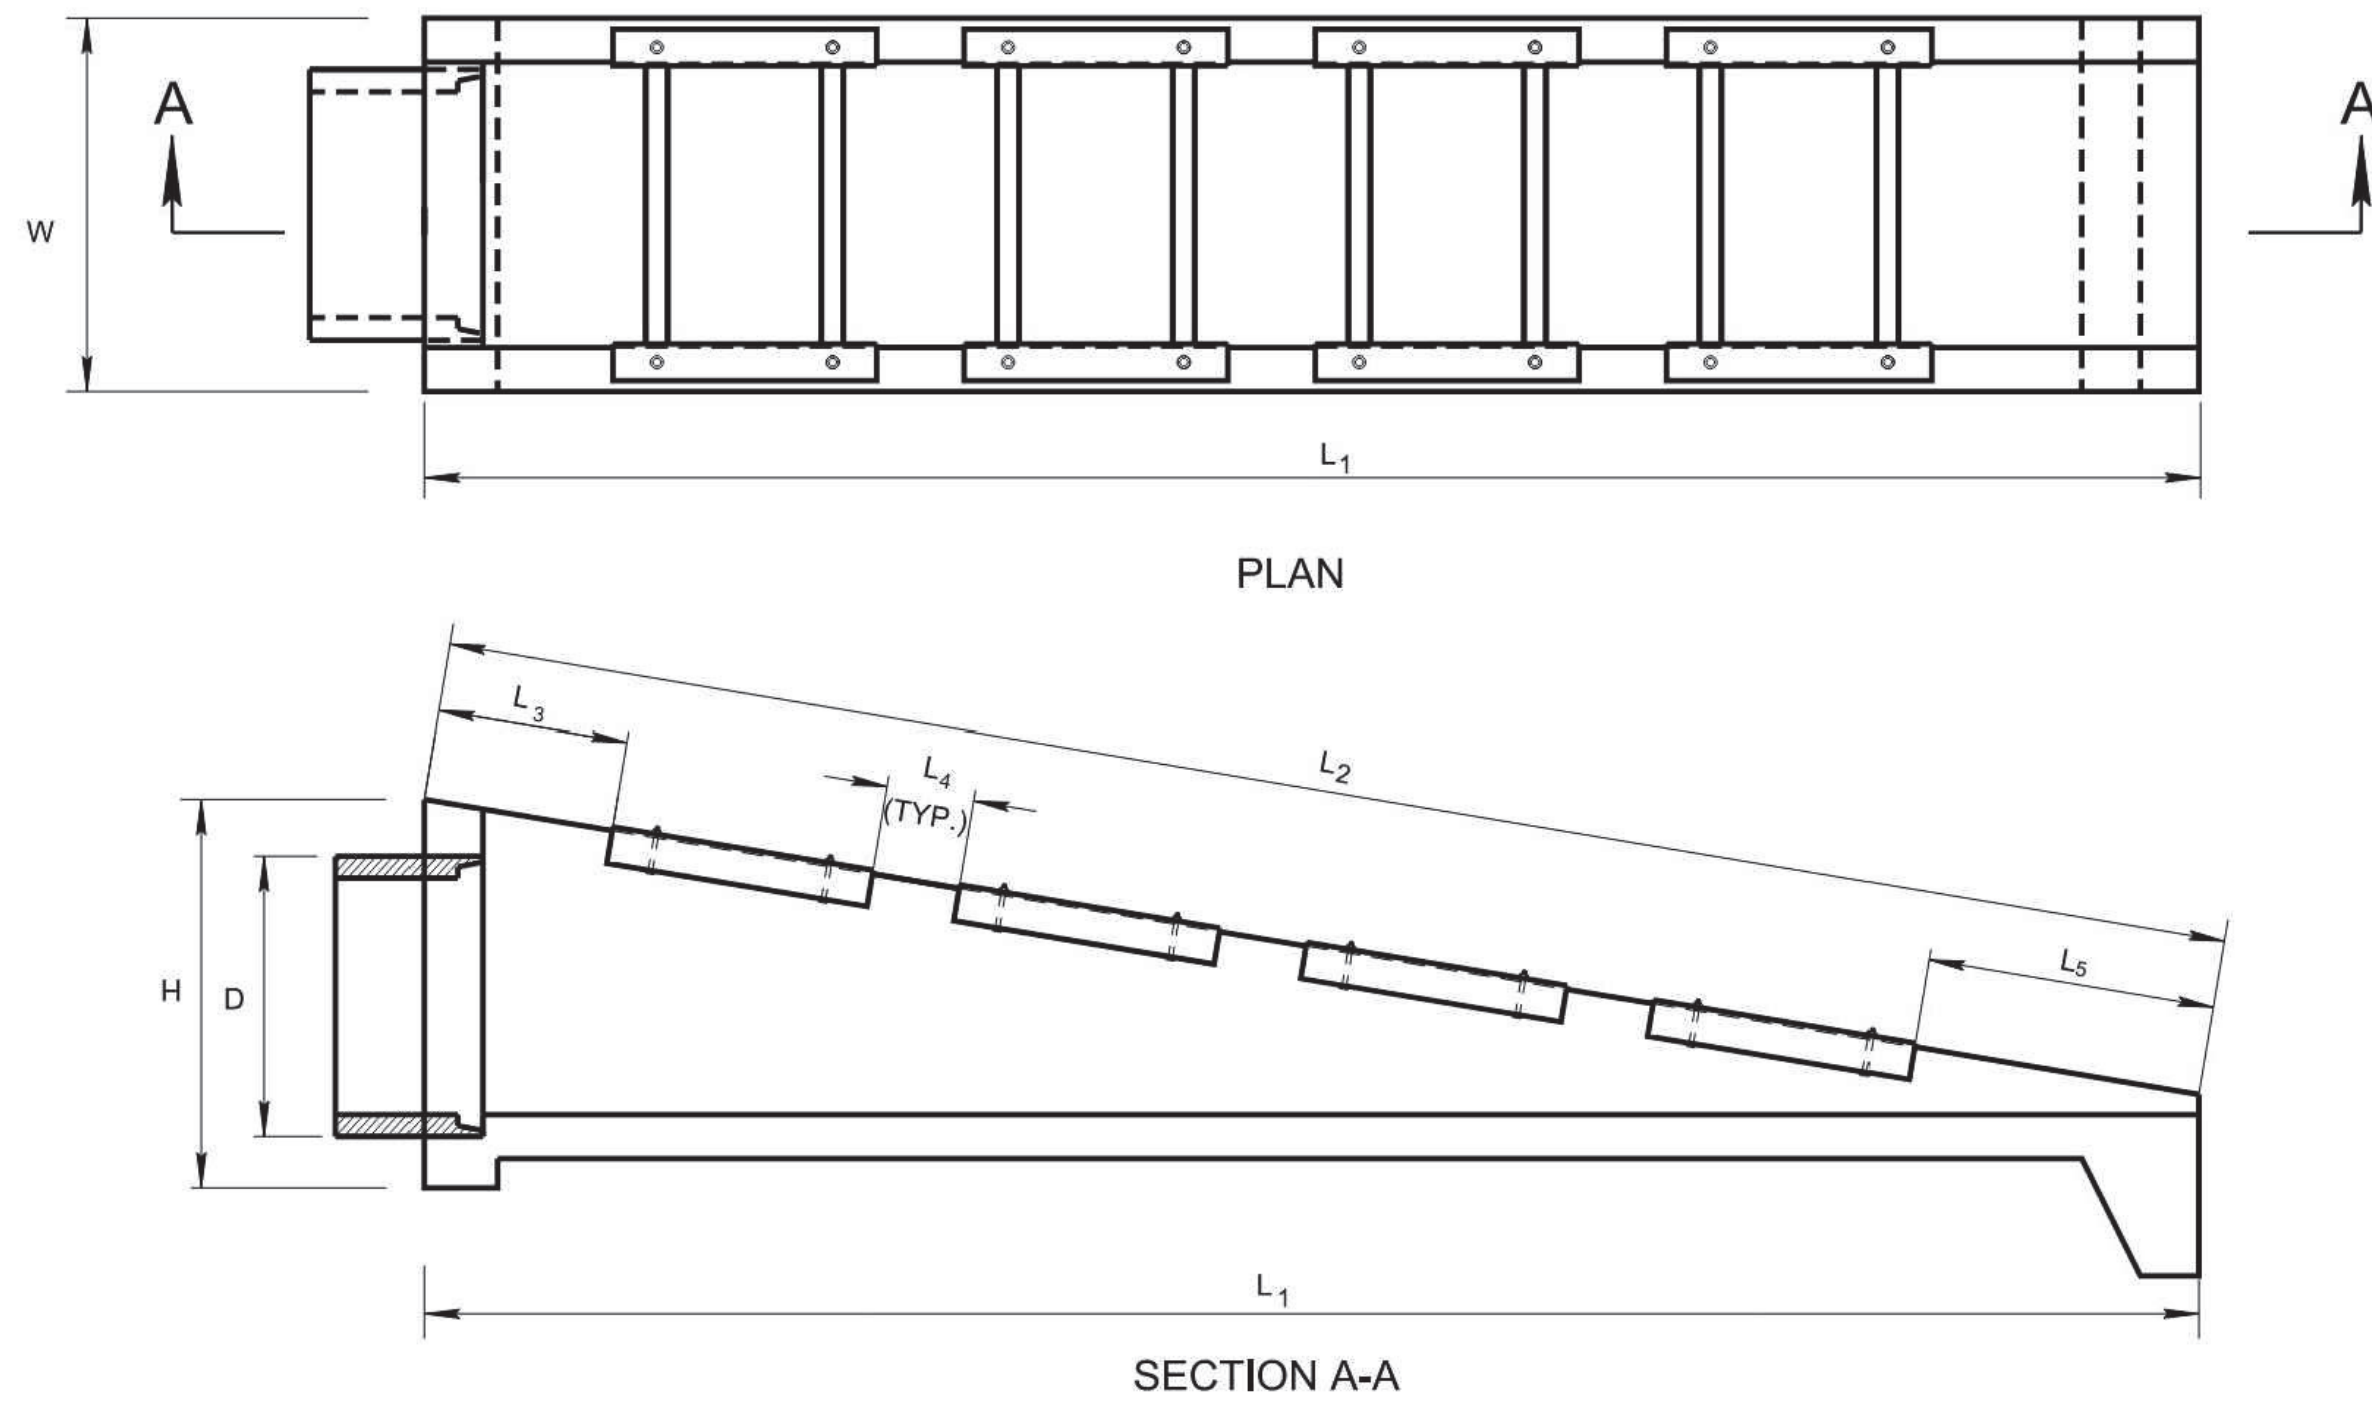
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NOLENSVILLE, TN 37135
JASON@MORELOCKENG.COM - (615) 300-6486


GRADING, DRAINAGE
& EPSC DETAILS
C3.5



ALTERNATE ANCHORS FOR STRUCTURAL STEEL GRATES

CERTIFICATION:
 DRILLED-IN EPOXY ANCHORS OR CAST-IN THREADED INSERTS MAY BE UTILIZED IN LIEU OF CAST-IN HEADED ANCHOR BOLTS PROVIDED THAT THE CONTRACTOR FURNISHES CERTIFIED ANCHOR PULL OUT DATA FROM AN INDEPENDENT TESTING LABORATORY USING CLASS "A" CONCRETE AS PRESCRIBED BY TENNESSEE HIGHWAY SPECIFICATIONS. THE REQUIRED ULTIMATE LOAD FOR 5/8" DIAMETER ANCHORS IS 10,000 POUNDS.

NOTE:
 BOLTS SHALL NOT EXTEND MORE THAN 1/2" ABOVE TOP OF NUTS.

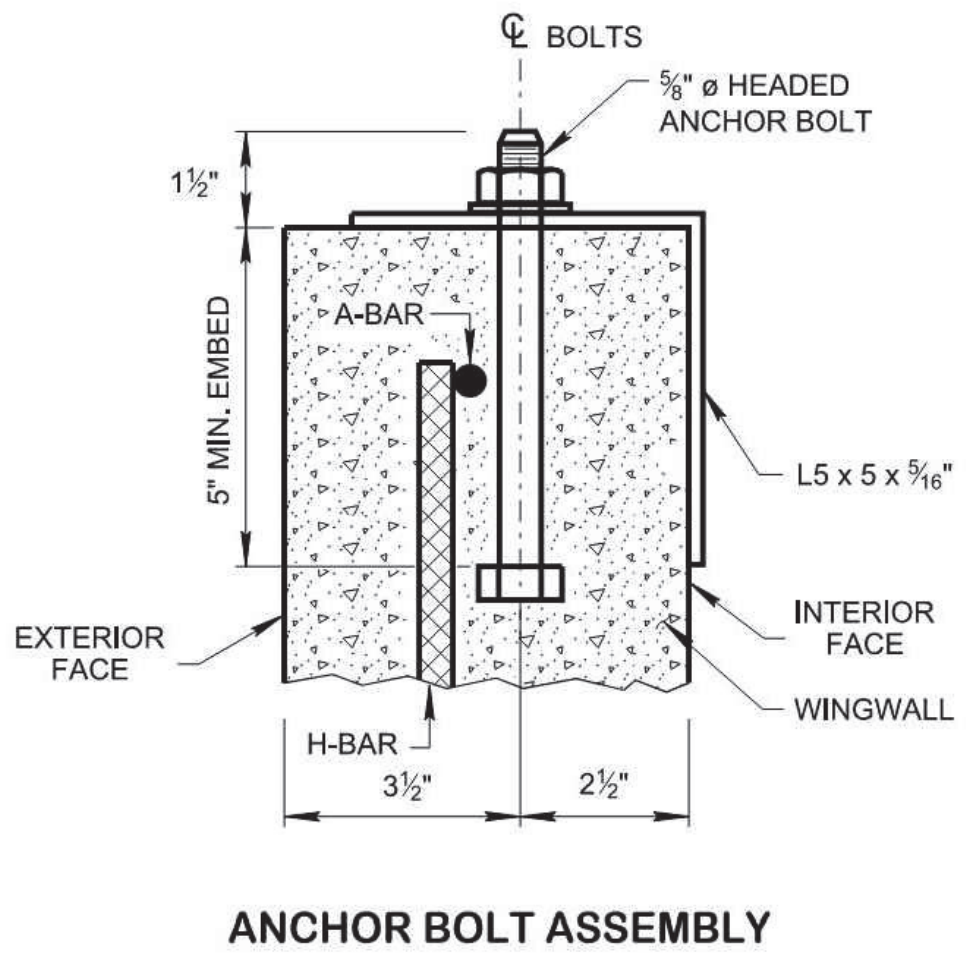

SIDE DRAIN DIA. (D)	DIMENSIONS AND QUANTITIES FOR ONE ENDWALL									
	CONCRETE ENDWALL DIMENSIONS				GRATE PLACEMENT DIMENSIONS			STRUCTURAL STEEL GRATE DIMENSIONS AND QUANTITY		STRUCT. STEEL
	H	W	L ₁	L ₂	L ₃	L ₄	L ₅	WG	NO. REQ'D.	LB.
15"	SEE STD. DWG. D-PE-15A		2'-2"		2'-2"	1'-0"	2'-1 7/8"	2'-5"	2	172
18"	SEE STD. DWG. D-PE-18A		2'-2"		10 5/8"	1'-0"	1'-0"	2'-8"	3	269
24"	SEE STD. DWG. D-PE-24A		2'-2"		2'-2"	1'-0"	3'-2 5/8"	3'-3"	3	296
30"	SEE STD. DWG. D-PE-30A		2'-2"		2'-2"	1'-0"	3'-3 3/8"	3'-10"	4	694
36"	SEE STD. DWG. D-PE-36A		2'-2"		2'-2"	1'-0"	2'-9 3/8"	4'-5"	5	975
42"	SEE STD. DWG. D-PE-42A		2'-2"		2'-2"	1'-0"	1'-10 3/8"	5'-0"	6	1,300
48"	SEE STD. DWG. D-PE-48A		2'-2"		2'-2"	1'-0"	1'-5"	5'-7"	7	1,669

GENERAL NOTES

(A) DRAWING TO BE USED FOR ALL 15" THRU 48" SIDE DRAIN CONCRETE ENDWALLS. REFER THE FOLLOWING STANDARD DRAWINGS FOR CONSTRUCTION DIMENSIONS.

15" ENDWALL - SEE D-PE-15A & D-PE-15B WITH 6:1 WINGWALL SLOPE
 18" ENDWALL - SEE D-PE-18A & D-PE-18B WITH 6:1 WINGWALL SLOPE
 24" ENDWALL - SEE D-PE-24A & D-PE-24B WITH 6:1 WINGWALL SLOPE
 30" ENDWALL - SEE D-PE-30A & D-PE-30B WITH 6:1 WINGWALL SLOPE
 36" ENDWALL - SEE D-PE-36A & D-PE-36B WITH 6:1 WINGWALL SLOPE
 42" ENDWALL - SEE D-PE-42A & D-PE-42B WITH 6:1 WINGWALL SLOPE
 48" ENDWALL - SEE D-PE-48A & D-PE-48B WITH 6:1 WINGWALL SLOPE

(B) SIDE DRAIN CONCRETE ENDWALL REQUIRES STEEL PIPE GRATES SHOWN ON THIS DRAWING. THE CONTRACTOR SHALL OMIT THE CONCRETE BLOCKOUTS (4" x 7") AS SHOWN ON STANDARD DRAWING D-PE-99 SECTION D-D THRU WINGWALL AND SUBSTITUTE THE FOLLOWING REINFORCING BARS:

30" ENDWALL - SUBSTITUTE A465 & A466 BY EXTENDING A464 TO 19'-5"
 36" ENDWALL - SUBSTITUTE A464 & A465 BY EXTENDING A463 TO 23'-0"
 42" ENDWALL - SUBSTITUTE A465 (2 BARS), A466 & A467 BY EXTENDING A464 TO 26'-0"
 48" ENDWALL - SUBSTITUTE A465 (2 BARS), A466 & A467 BY EXTENDING A464 TO 29'-7"

(C) THE MATERIALS, WELDING AND PAINTING FOR STRUCTURAL STEEL GRATE SHALL CONFORM TO THE FOLLOWING SPECIFICATIONS:

- ANGLES: ASTM A36
- STEEL PIPE: ASTM A53 GRADE B, STANDARD WEIGHT (SW) OR ASTM A500 GRADE B AND SHALL BE GALVANIZED FOR 15" THRU 24" DIAMETER PIPE CULVERT. ASTM A53 GRADE B, DOUBLE EXTRA STRONG WEIGHT (XXS) - FOR 30" THRU 48" DIAMETER PIPE CULVERT.
- WELDING: AASHTO/AWS D1.5M/D1.5 BRIDGE WELDING CODE (LATEST EDITION)
- ALL STEEL GRATES SHALL BE GALVANIZED.

THE MATERIAL AND GALVANIZING FOR BOLTS, NUTS AND WASHERS SHALL CONFORM TO THE FOLLOWING SPECIFICATIONS:

- BOLTS, NUTS AND WASHERS: ASTM F1554 GRADE 36
- GALVANIZING: ASTM A153

(D) THE COST OF FURNISHING BOLTS, NUTS AND WASHERS, INCLUDING ALL MATERIALS, LABOR AND INCIDENTALS NECESSARY TO COMPLETE THE INSTALLATION, SHALL BE INCLUDED IN THE PRICE BID FOR STRUCTURAL STEEL.

(E) PAYMENT WILL BE MADE UNDER ITEM NUMBERS:

611-07.30	15IN ENDWALL (SIDE DRAIN)	EACH
611-07.31	18IN ENDWALL (SIDE DRAIN)	EACH
611-07.32	24IN ENDWALL (SIDE DRAIN)	EACH
611-07.33	30IN ENDWALL (SIDE DRAIN)	EACH
611-07.34	36IN ENDWALL (SIDE DRAIN)	EACH
611-07.35	42IN ENDWALL (SIDE DRAIN)	EACH
611-07.36	48IN ENDWALL (SIDE DRAIN)	EACH

(F) THE CONTRACTOR MAY ELECT TO SUBSTITUTE AN APPROVED ALTERNATIVE DESIGN

(G) DIMENSIONAL AND REINFORCING TOLERANCES WILL BE AS SHOWN IN STANDARD OPERATING PROCEDURE (SOP) 5-3.

- REV. 7-10-12: REVISED ALTERNATE ANCHORS FOR STRUCTURAL STEEL GRATES NOTE.
- REV. 1-10-13: CHANGED REQUIREMENT FOR GRATE ON ALL ENDWALLS.
- REV. 6-14-13: REVISED NOTE (E), ADDED NOTES (F) AND (G).
- REV. 3-16-17: REVISED GENERAL NOTES. ADDED FOOTNOTE TO TABLE.
- REV. 06-28-19: RENAMED AND REDREW SHEET.
- REV. 10-16-20: REVISED SLOT DIMENSION, ADDED ANCHOR BOLT DETAIL AND REVISED 18" PIPE GRATE PLACEMENT DIMENSIONS.
- REV. 03-04-21: REVISED GENERAL NOTES (A) (B) AND (C).

MINOR REVISION - FHWA APPROVAL NOT REQUIRED

STATE OF TENNESSEE
 STANDARD DRAWING
 DEPARTMENT OF TRANSPORTATION

TYPE "SAFETY" SIDE DRAIN ENDWALL WITH STEEL PIPE GRATE, FOR 15" THRU 48" PIPES, 6:1 SLOPE

03-01-2012 D-SEW-1A

Jason Morelock

Dental Clinic
 1298 NORTH ELLINGTON PARKWAY
 TAX MAP 57 O, GROUP A, PARCEL 47.07, LEWISBURG, MARSHALL COUNTY, TN
 SOUTHIE MAE, LLC
 1601 WESTGATE CIRCLE, BRENTWOOD, TENNESSEE 37027

Revisions

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